#### **EXHIBIT B**



February 5th, 2019

Kristi Wilson Interim Director of Public Works City of Redmond 15670 NE 85<sup>th</sup> Street Redmond, WA, 98073

Downtown Redmond Link Extension, Letter of Concurrence LOC 18 DRLE: Redmond Way & NE 76th Street Roadway Improvements

#### **Purpose**

The purpose of this letter is to seek concurrence from the City of Redmond for the Redmond Way and NE 76<sup>th</sup> Street roadway improvements and funding responsibilities for betterments, included in the Downtown Redmond Link Extension scope of work. The portions of roadway that are being agreed upon are: 1) Redmond Way from the driveway of Creekside Crossing to the intersection of Redmond Way and NE 76<sup>th</sup> Street/SR 520 WB On-Ramp, and 2) NE 76<sup>th</sup> Street from the intersection of Redmond Way to the Fred Meyer/Target traffic signal.

#### **Sound Transit Scope**

Sound Transit will be adjusting the grade of the Redmond Way-NE 76th St./SR 520 WB On-Ramp intersection as part of light rail project to accommodate the light rail undercrossing. This scope of work includes paving, striping, adjustment of utilities to grade, retaining walls, signal work, and any additional work associated with completing the grade adjustment. See Attachment 1 which defines the scope of work limits in blue.

#### City of Redmond Scope

The City of Redmond requests that Sound Transit construct, as a betterment, an additional eastbound left turn lane from Redmond Way to NE 76<sup>th</sup> Street. This scope includes:

- Design and construction of additional eastbound left turn lane and northbound receiving/thru lane on NE 76th St from Redmond Way to the traffic signal servicing Fred Meyer and Target
- Curb, gutter, pavement and lane restriping on NE 76th St. from Redmond Way to the Fred Meyer/Target traffic signal, a total distance of about 1,100 feet, that would not be required but for the betterment
- The removal of sidewalk on the existing SR 202 bridge over Bear Creek to provide enough space for the eastbound left turn lane

#### CHAIR

Dave Somers
Snohomish County Executive

VICE CHAIRS

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Jonn Marchione Redmond Mayor

**BOARD MEMBERS** 

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Auburn Mayor

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Kenmore Mayor

Claudia Balducci King County Councilmember

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Paul Roberts

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King County Councilmember

Peter von Reichbauer King County Councilmember

Victoria Woodards
Tacoma Mayor

CHIEF EXECUTIVE OFFICER Peter M. Rogoff

Kristi Wilson February 5<sup>th</sup>, 2019 Page 2

- Revised curb taper on Redmond Way given removal of sidewalk
- Construction of new curb and sidewalk on the south side of Redmond Way near Creekside Crossing
- New channelization from the existing SR 202 bridge to the driveway of Creekside Crossing
- Any additional work required solely to complete the betterment

See Attachment 1 for improvements associated with the City of Redmond betterment described above.

Should you have any questions, please don't hesitate to contact me at (206) 398-5171. Please sign below and return one of the enclosed originals – please keep the additional copy for your records. Sincerely,

1

Tony Raben

Executive Project Director, DRLE

#### Attachments:

1. SR 202 & NE 76th Street Roadway Improvements

Concurrence:

D


Kristi Wilson, Interm Director of Public Works

City of Redmond

Enclosure (s):

cc: Leonard McGhee (Project Manager, ST)

ST Document Control

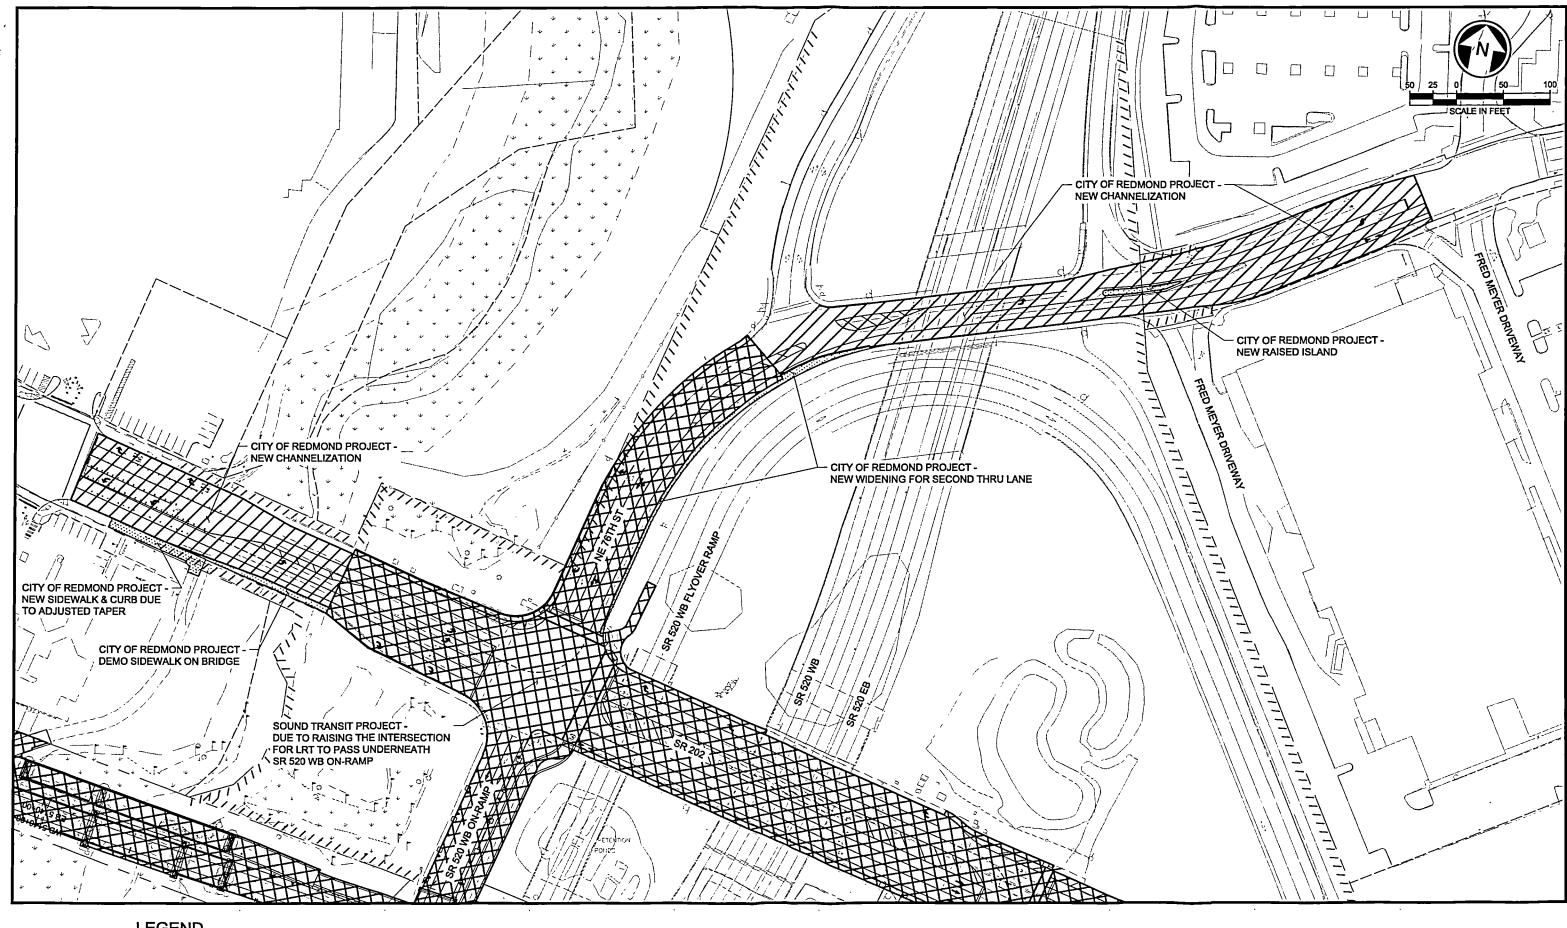

**LEGEND** 


SOUND TRANSIT WORK CITY OF REDMOND CIVIL WORK


(BETTERMENT)

CITY OF REDMOND NEW CHANNELIZATION WORK (BETTERMENT)



**ATTACHMENT 1** SR 202 & NE 76TH STREET ROADWAY IMPROVEMENTS **SOUNDTRANSIT** DOWNTOWN REDMOND LINK EXTENSION

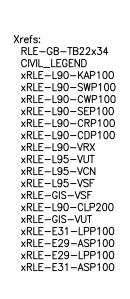

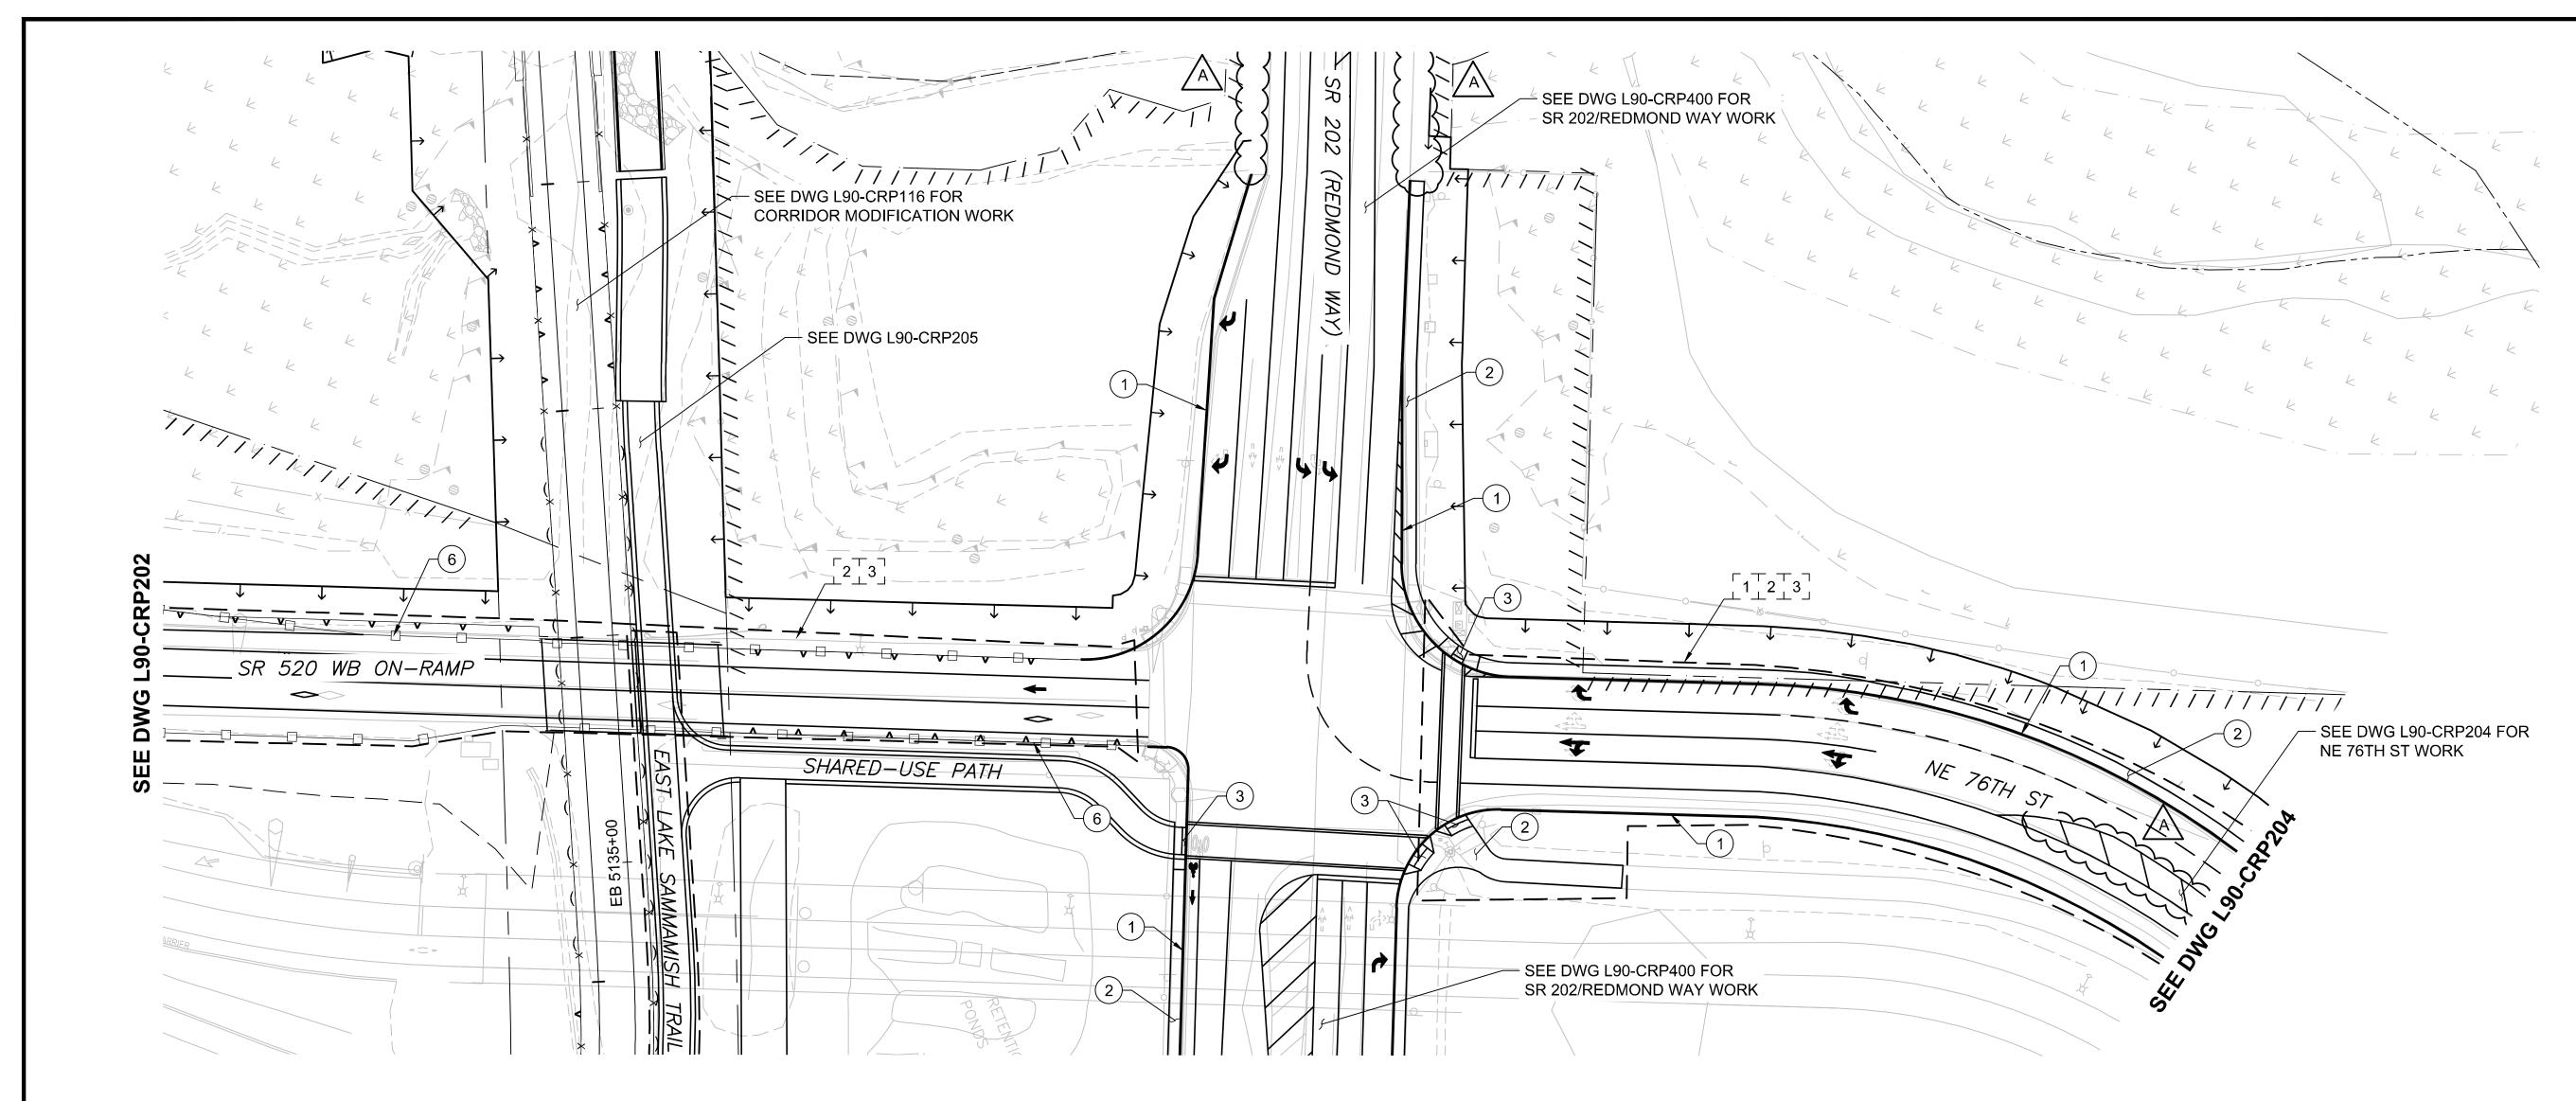

### **CIVIL/ROADWAY NOTES:**

- (1) CEMENT CONCRETE CURB AND GUTTER
- (2) CONCRETE SIDEWALK
- (3) ADA CURB RAMP
- (4) DRIVEWAY APPROACH
- (5) PLANTING STRIP
- (6) GUARDRAIL/CONCRETE BARRIER

DSN CHK APP REVISION

## **EVALUATION LIMITS:**

- ILLUMINATION

Y. YANG

# **GENERAL NOTES:**

- 1. ALL LIGHT RAIL INFRASTRUCTURE SHOWN ON THESE PLANS ARE FOR REFERENCE ONLY, INCLUDING GUIDEWAY, WALLS, COLUMNS, TPSS AND SIGNAL BUNGALOW SITES, STORMWATER FACILITIES, STATIONS, AND GARAGE.
- 2. CIVIL RETAINING WALLS, STRUCTURES, NOISE WALLS, AND FENCING ARE SHOWN AS A CONCEPTUAL LAYOUT.







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ENGINEERING . PLANNING . ENVIRONMENTAL SCIENCES

BRAD PHILLIPS

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SUBMITTED BY:	DATE:	REVIEWED BY:		

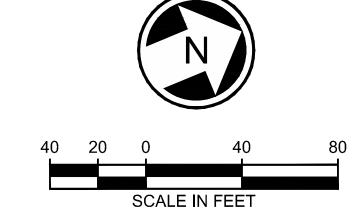09/24/2018

## DOWNTOWN REDMOND LINK EXTENSION RLE-L90-CRP200TO205 CONTRACT No.: **SOUNDTRANSIT** CN 0148-18

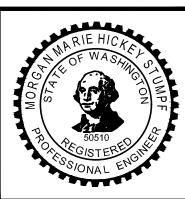
RTS TO DOWNTOWN REDMOND


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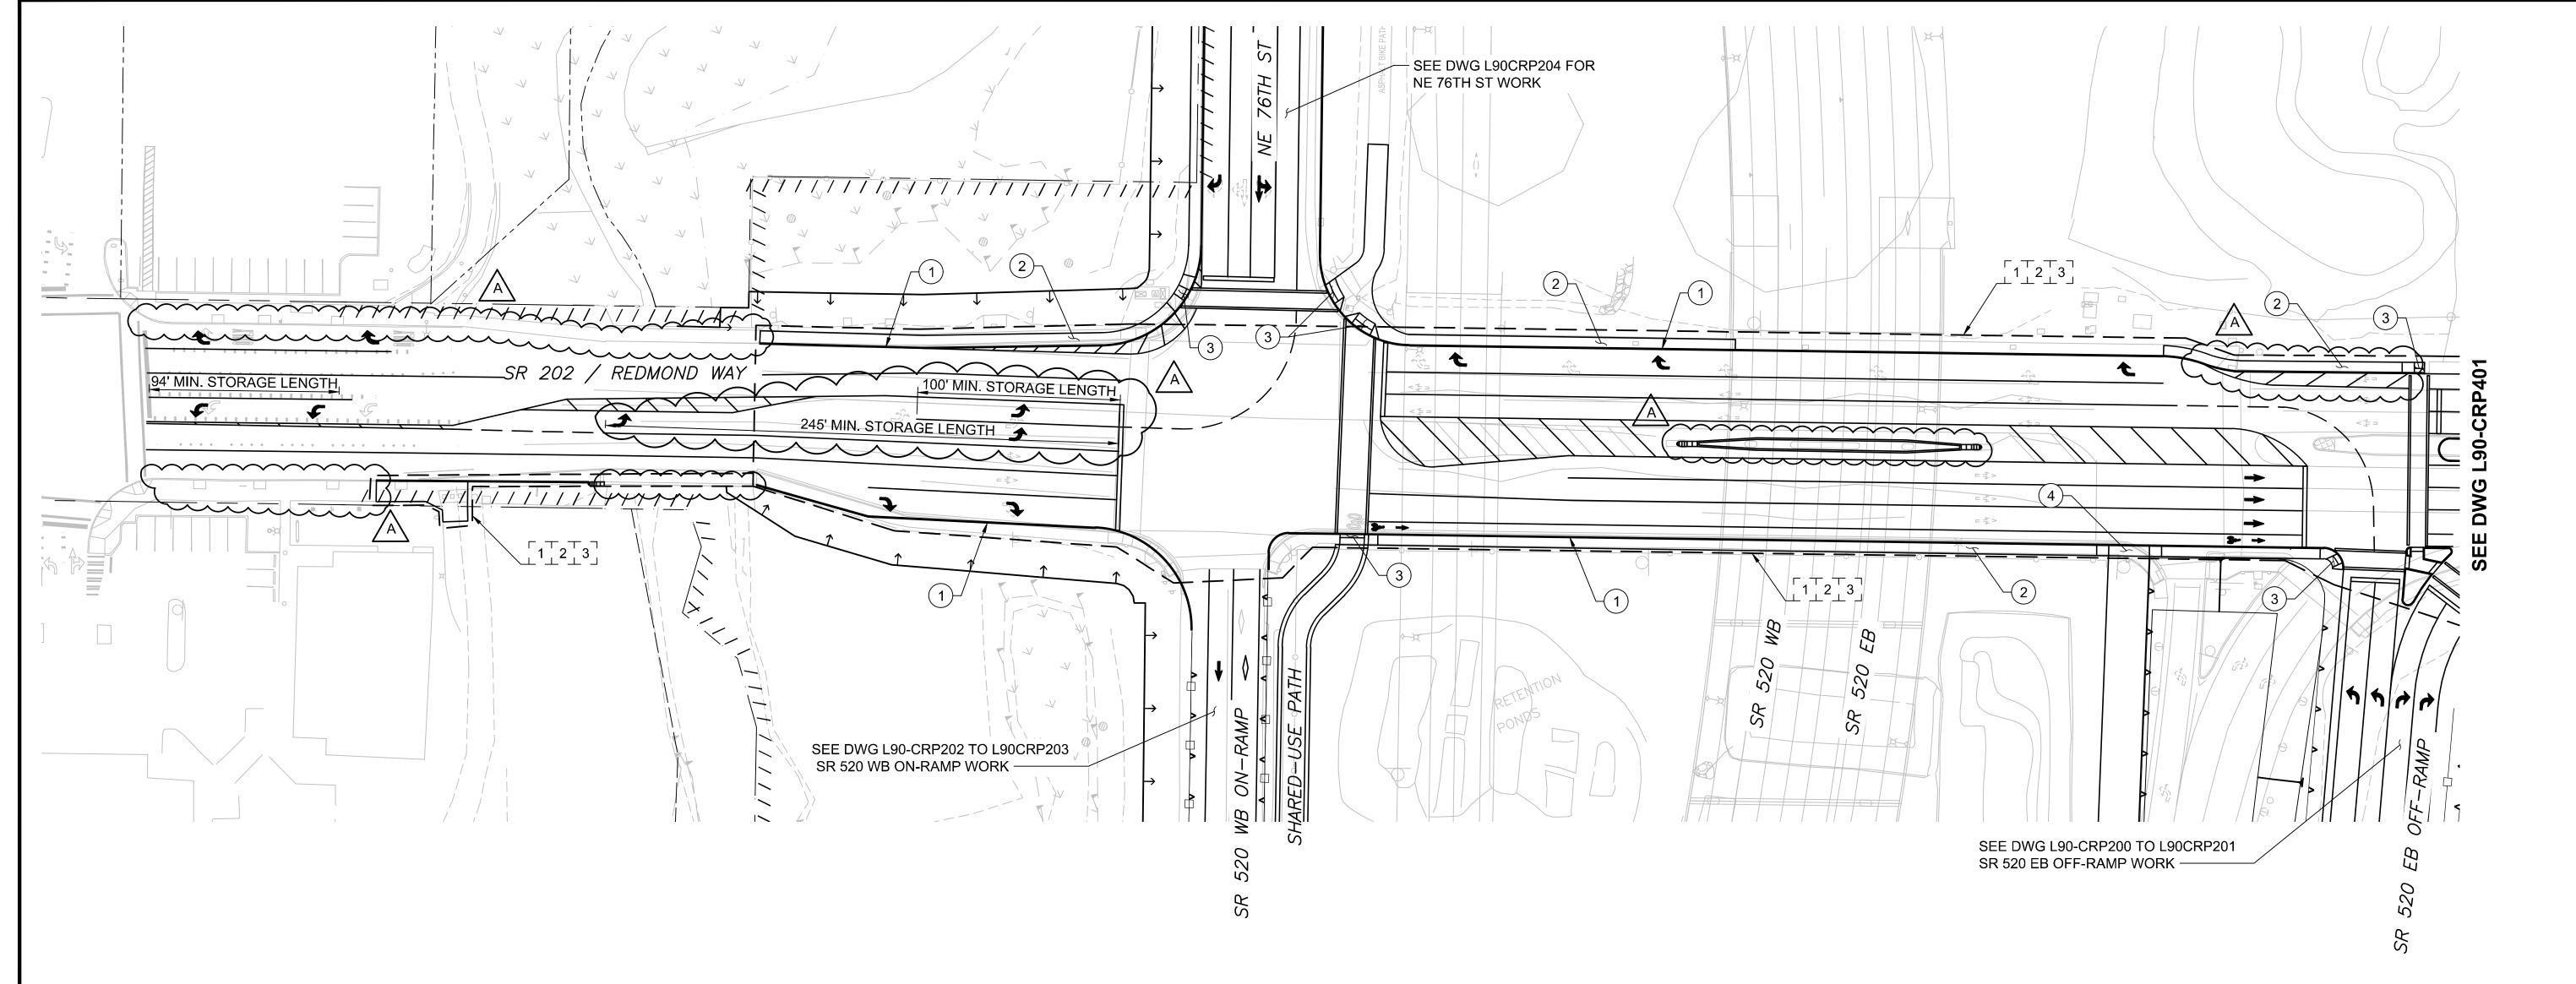
DRAWING No.:
L90-CRP203
LOCATION ID:

CIVIL
WSDOT RAMP AND SR 202 MODIFICATION PLAN
SR 520 ON-RAMP (ALU RAMP). NE 76TH ST. SR 202

SHEET No.: 165



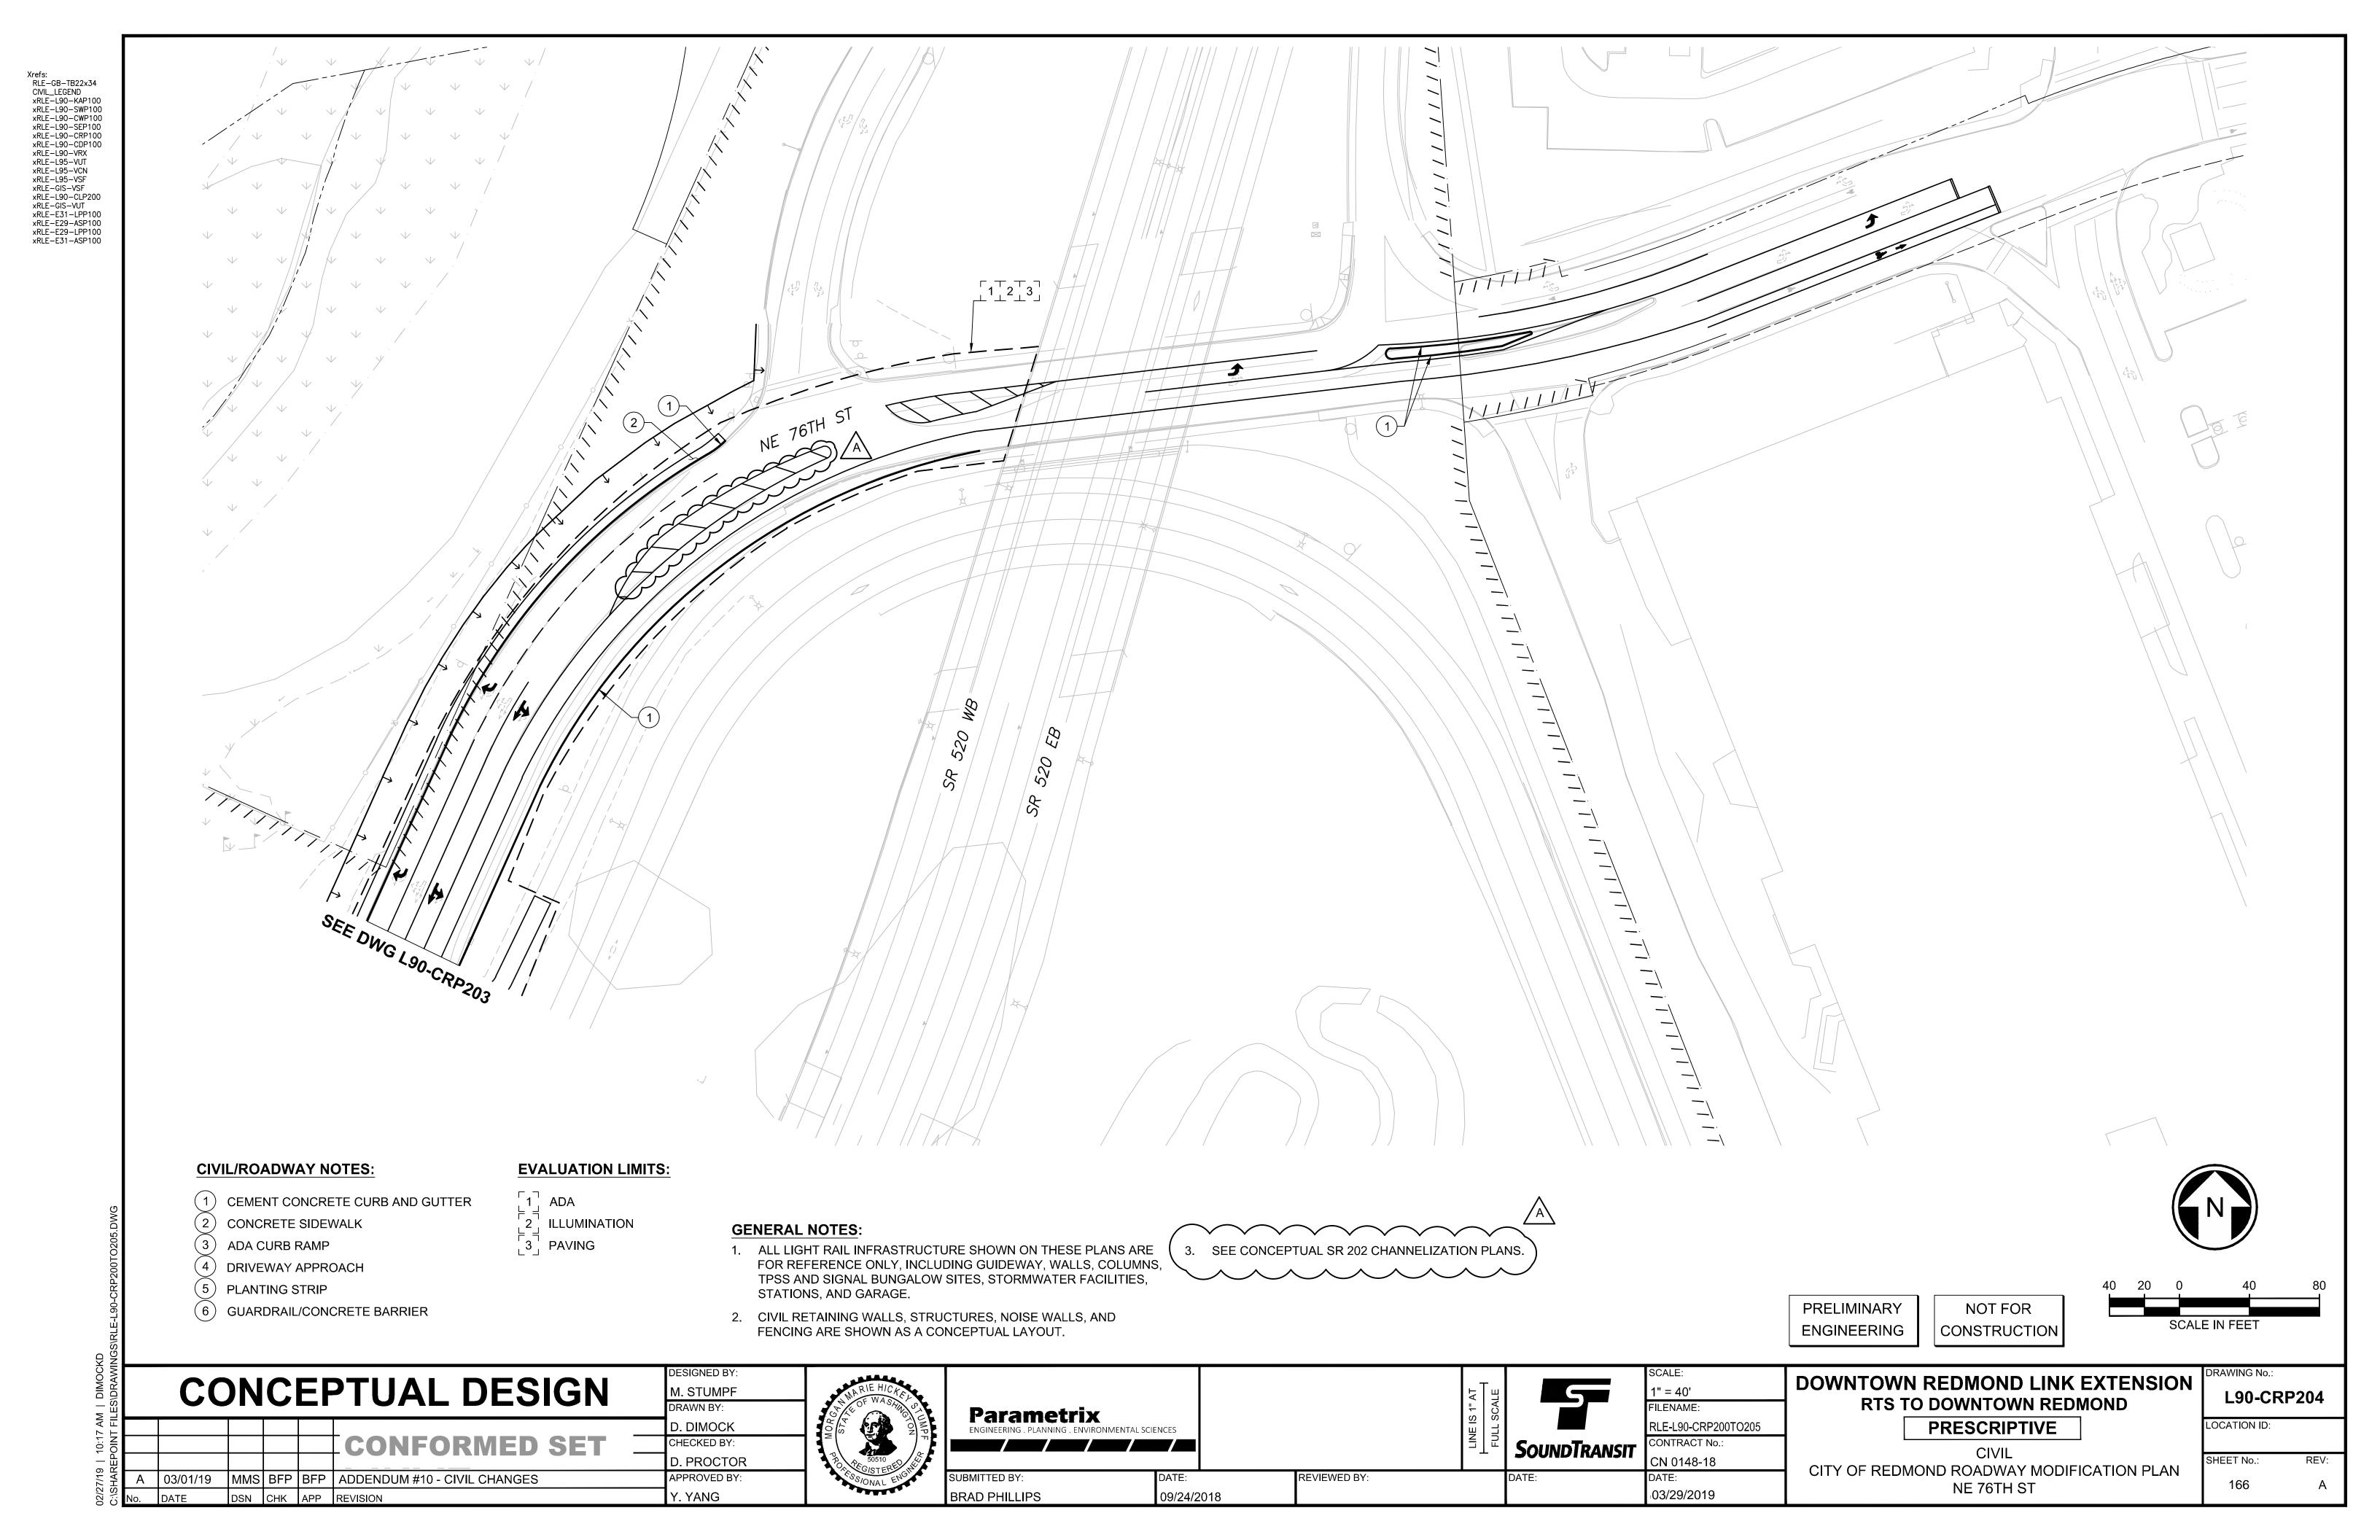

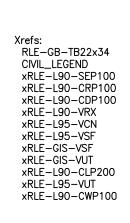

### **CIVIL/ROADWAY NOTES:**

- (1) CEMENT CONCRETE CURB AND GUTTER
- (2) CONCRETE SIDEWALK
- (3) ADA CURB RAMP
- (4) DRIVEWAY APPROACH
- (5) PLANTING STRIP
- (6) GUARDRAIL/CONCRETE BARRIER

DSN CHK APP REVISION

## **EVALUATION LIMITS:**

- ADA
- ILLUMINATION

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# **GENERAL NOTES:**

1. ALL LIGHT RAIL INFRASTRUCTURE SHOWN ON THESE PLANS ARE FOR REFERENCE ONLY, INCLUDING GUIDEWAY, WALLS, COLUMNS, TPSS AND SIGNAL BUNGALOW SITES, STORMWATER FACILITIES, STATIONS, AND GARAGE.

SUBMITTED BY:

BRAD PHILLIPS


2. CIVIL RETAINING WALLS, STRUCTURES, NOISE WALLS, AND FENCING ARE SHOWN AS A CONCEPTUAL LAYOUT.





PRELIMINARY **ENGINEERING** 

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1" = 40'
FILENAME:
RLE-L90-CRP400TO402
CONTRACT No.:
CN 0148-18
DATE:
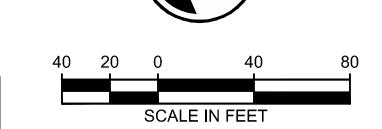
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SR 202 / REDMOND WY

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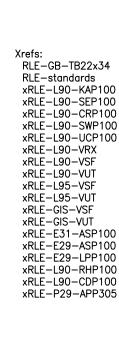
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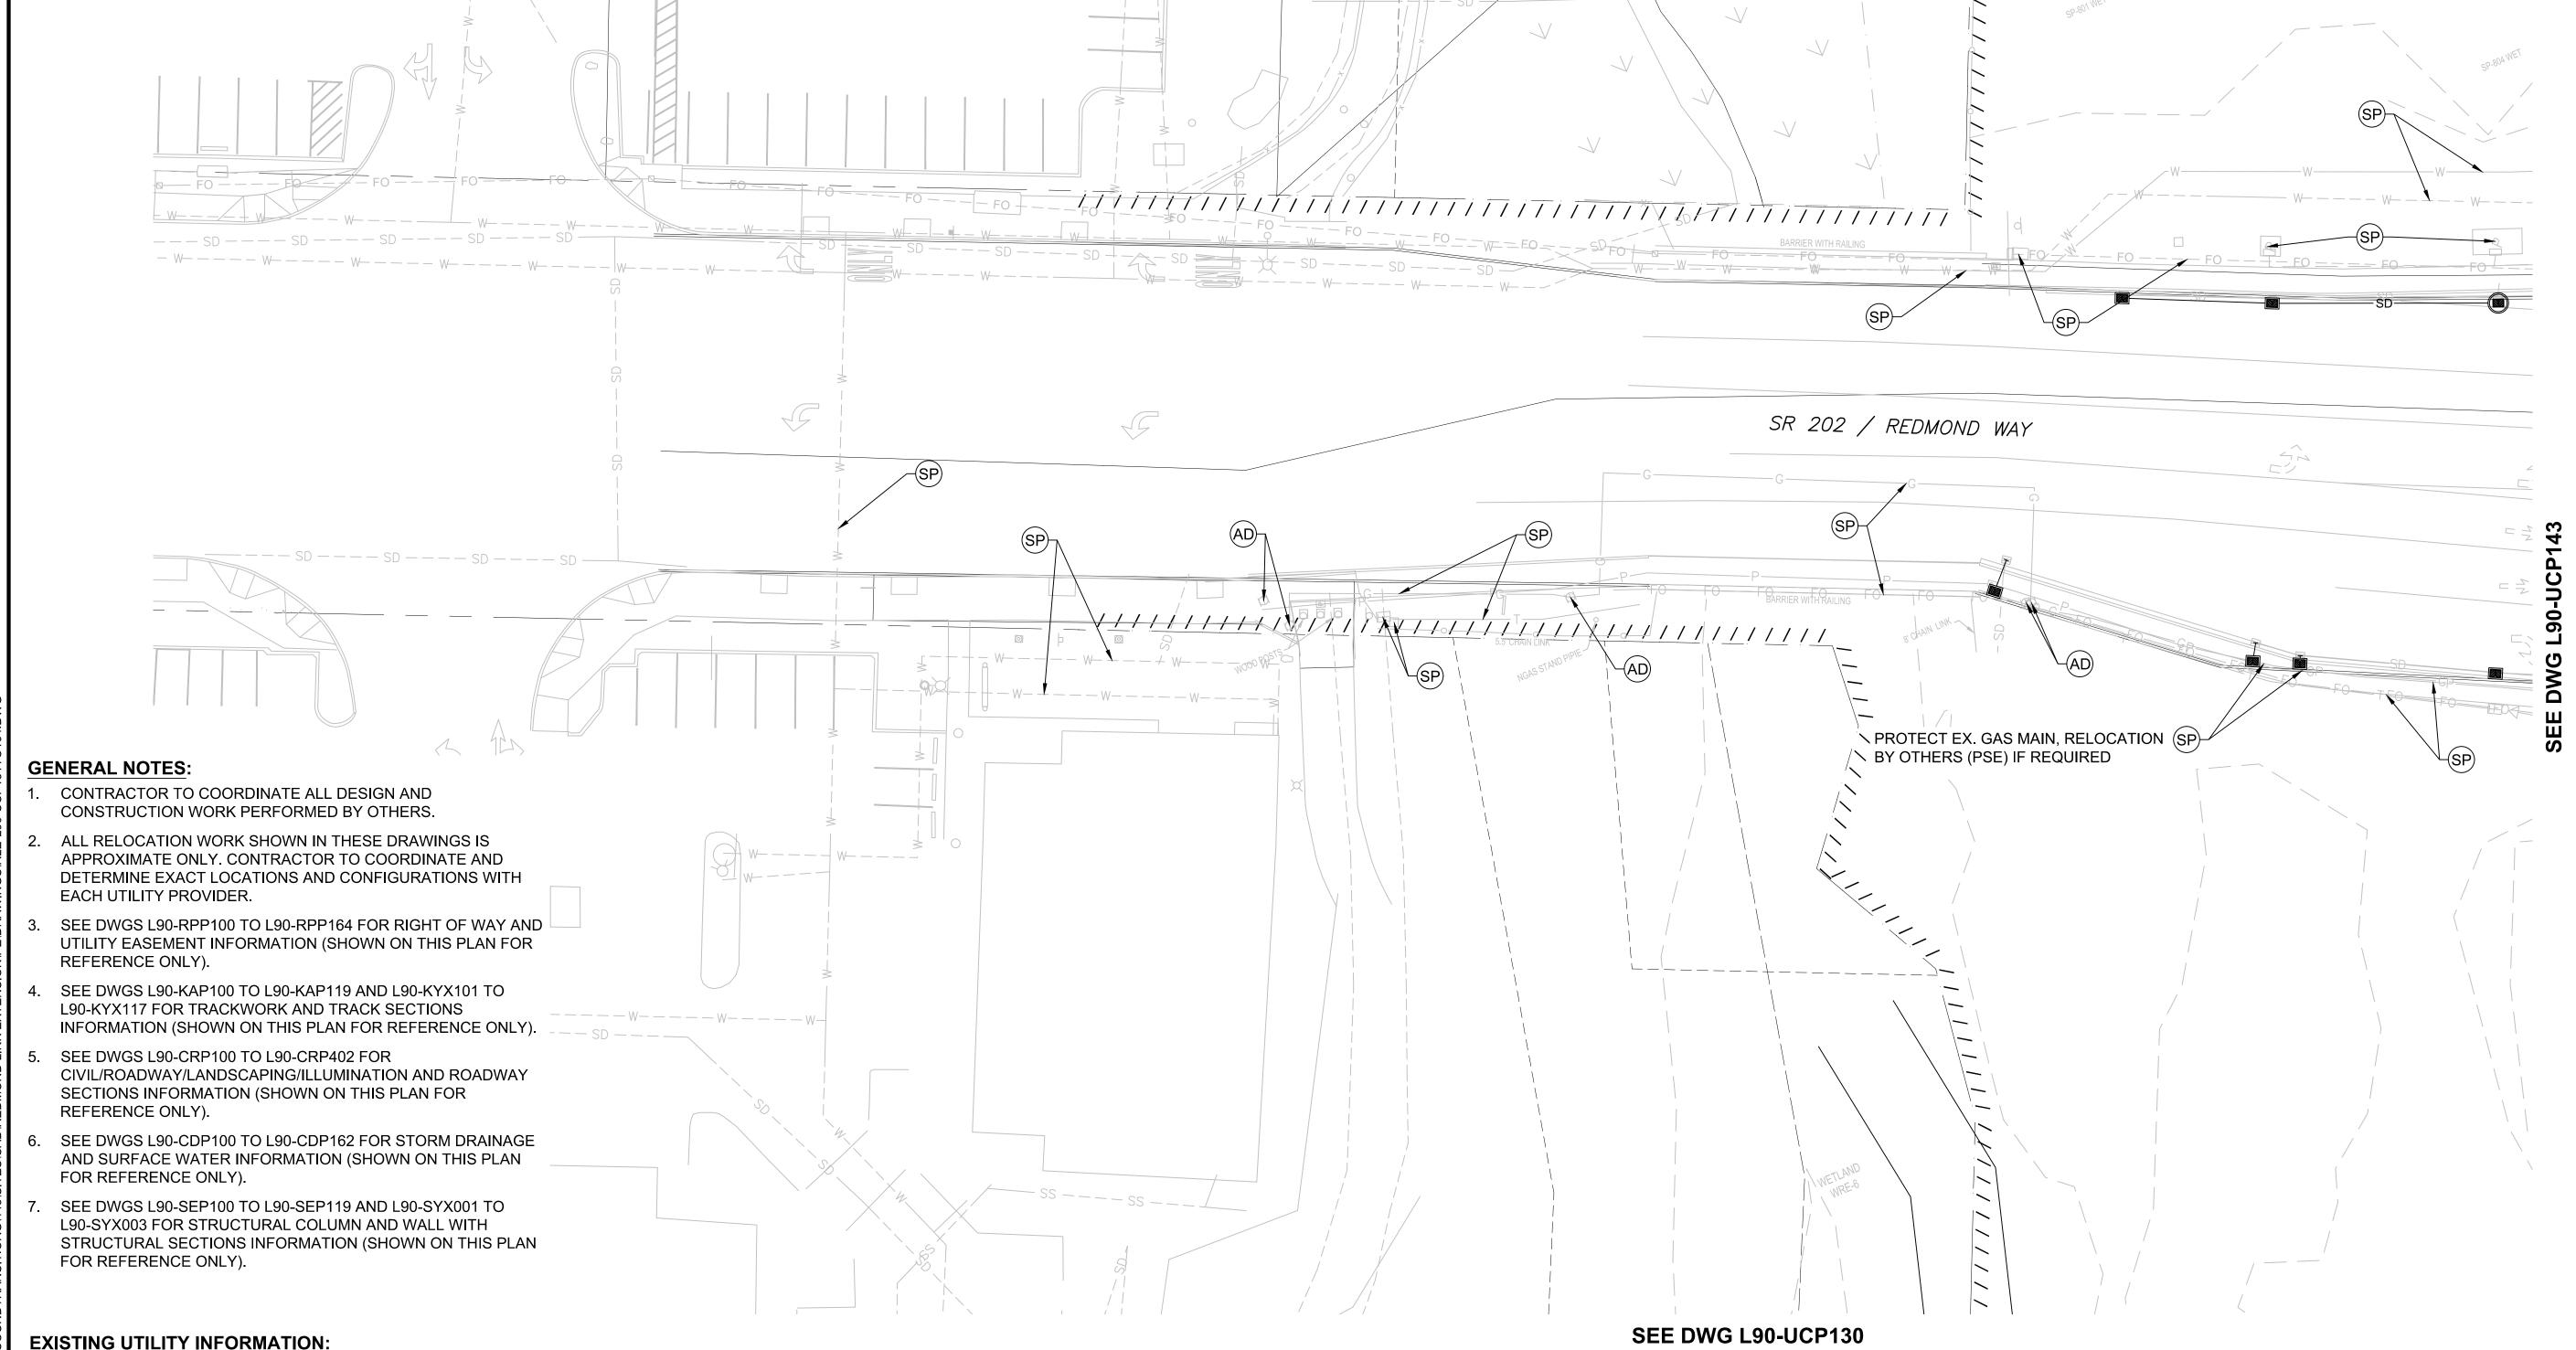
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DATE: 09/24/2018

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03/29/2019





#### **EXISTING UTILITY INFORMATION:**

1. THE LOCATIONS OF THE EXISTING UTILITIES ARE APPROXIMATE AND WERE COMPILED FROM AVAILABLE INFORMATION PROVIDED BY PUBLIC AND PRIVATE UTILITY PROVIDERS, SOME FIELD SURVEY DATA, AND SITE OBSERVATIONS. THOUGH THIS COMPILATION REPRESENTS THE AVAILABLE INFORMATION OF EXISTING UTILITIES, THE INFORMATION PROVIDED HEREON MAY VARY FROM ACTUAL SIZES AND LOCATIONS.

2. THE CONTRACTOR SHALL CONDUCT THEIR OWN RESEARCH AND INVESTIGATIONS WHICH IN THEIR PROFESSIONAL OPINION ARE NECESSARY TO EVALUATE THE ACCURACY OF THIS INFORMATION IN ADVANCE OF CONSTRUCTION WORK AND SUBSURFACE PENETRATIONS PERFORMED SO AS TO PREVENT THE IMPACT TO UTILITY SYSTEMS AND THEIR CUSTOMERS. SUCH WORK SHALL BE PERFORMED IN A MANNER CONSISTENT WITH THE ORDINARY STANDARD OF CARE.

## (XX) REFERENCE UTILITY WORK TO BE PERFORMED BY DESIGN-BUILD CONTRACTOR.

XX WORK TO BE PERFORMED BY OTHERS (DESIGN-BUILD CONTRACTOR TO COORDINATE)

## XX PRESCRIPTIVE UTILITY WORK TO BE PERFORMED BY DESIGN-BUILD CONTRACTOR

BRAD PHILLIPS

## RL = RELOCATE EXISTING UTILITY OR INSTALL NEW

SP = SUPPORT/PROTECT DURING CONSTRUCTION (MEANS AND METHODS TO BE DETERMINED BY THE DESIGN-BUILD CONTRACTOR AND UTILITY OWNER)

AD = ADJUST TO NEW GRADE


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### RM = REMOVE

AB = ABANDON IN PLACE (DESIGN-BUILD CONTRACTOR TO VERIFY IF ABANDONMENT IN PLACE IS ACCEPTABLE TO UTILITY OR CITY OF REDMOND)

> PRELIMINARY **ENGINEERING**


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**CONCEPTUAL DESIGN** 

**CONFORMED SET** 

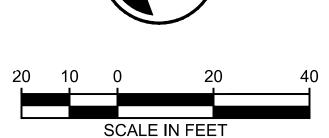CHK APP REVISION



DESIGNED BY

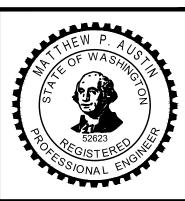M. AUSTIN

CHECKED BY:

J. BETZVOG

D. PROCTOR

APPROVED BY

Y. YANG

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1" = 20'
FILENAME:
RLE-L90-UCP131TO164
CONTRACT No.:
CN 0148-18
DATE:

03/29/2019

## **DOWNTOWN REDMOND LINK EXTENSION** RTS TO DOWNTOWN REDMOND

REFERENCE

COMPOSITE UTILITIES PLAN SR 202/REDMOND WY & BEAR CREEK

RAWING No.: L90-UCP142 LOCATION ID:

SHEET No.:

SEE DWG L90-UCP162 Xrefs: RLE-GB-TB22x34 RLE-standards xRLE-L90-KAP100 CONTRACTOR TO RELOCATE/REPLACE WSDOT xRLE-L90-SEP100 xRLE-L90-CRP100 ITS / SIGNAL / ELECTRICAL INFRASTRUCTURE xRLE-L90-SWP100 xRLE-L90-UCP100 xRLE-L90-VRX ITS / SIGNAL / ELECTRICAL WIRING (RL) WITH NO SERVICE INTERRUPTIONS AND **FOLLOW WSDOT STANDARDS** xRLE-L90-VSF xRLE-L90-VUT xRLE-L95-VSF xRLE-L95-VUT xRLE-GIS-VSF (RL) ITS / SIGNAL / ELECTRICAL INFRASTRUCTURE xRLE-GIS-VUT xRLE-E31-ASP100 xRLE-E29-ASP100 xRLE-E29-LPP100 xRLE-L90-RHP100 xRLE-L90-CDP100 xRLE-P29-APP305 ) CONTRACTOR TO RELOCATE/REPLACE WSDOT ITS/SIGNAL/ELECTRICAL INFRASTRUCTURE WITH NO SERVICE DONE PREVIOUSLY INTERRUPTIONS AND FOLLOW WSDOT **STANDARDS** ITS / SIGNAL / ELECTRICAL INFRASTRUCTURE (RL) SR 202 / REDMOND WAY AB DONE PREVIOUSLY (BY COR) -(SP) PROTECT EX. GAS MAIN, RELOCATION BY OTHERS (PSE) IF REQUIRED CONTRACTOR TO RELOCATE/REPLACE (RL) **GENERAL NOTES:** CONTRACTOR TO RELOCATE/REPLACE WSDOT ITS/SIGNAL/ELECTRICAL WSDOT ITS/SIGNAL/ELECTRICAL CONTRACTOR TO COORDINATE ALL DESIGN AND CONSTRUCTION WORK INFRASTRUCTURE WITH NO SERVICE PERFORMED BY OTHERS. INFRASTRUCTURE WITH NO SERVICE INTERRUPTIONS AND FOLLOW WSDOT INTERRUPTIONS AND FOLLOW WSDOT STANDARDS ALL RELOCATION WORK SHOWN IN THESE DRAWINGS IS APPROXIMATE ONLY. STANDARDS CONTRACTOR TO COORDINATE AND DETERMINE EXACT LOCATIONS AND CONFIGURATIONS WITH EACH UTILITY PROVIDER. 0 3. SEE DWGS L90-RPP100 TO L90-RPP164 FOR RIGHT OF WAY AND UTILITY EASEMENT INFORMATION (SHOWN ON THIS PLAN FOR REFERENCE ONLY). МВ 4. SEE DWGS L90-KAP100 TO L90-KAP119 AND L90-KYX101 TO L90-KYX117 FOR 520 TRACKWORK AND TRACK SECTIONS INFORMATION (SHOWN ON THIS PLAN FOR REFERENCE ONLY). 5. SEE DWGS L90-CRP100 TO L90-CRP402 FOR CIVIL/ROADWAY/LANDSCAPING/ILLUMINATION AND ROADWAY SECTIONS INFORMATION (SHOWN ON THIS PLAN FOR REFERENCE ONLY). 6. SEE DWGS L90-CDP100 TO L90-CDP162 FOR STORM DRAINAGE AND SURFACE WATER INFORMATION (SHOWN ON THIS PLAN FOR REFERENCE ONLY). 7. SEE DWGS L90-SEP100 TO L90-SEP119 AND L90-SYX001 TO L90-SYX003 FOR STRUCTURAL COLUMN AND WALL WITH STRUCTURAL SECTIONS INFORMATION (SHOWN ON THIS PLAN FOR REFERENCE ONLY). **EXISTING UTILITY INFORMATION:** (XX) REFERENCE UTILITY WORK TO BE 1. THE LOCATIONS OF THE EXISTING UTILITIES ARE APPROXIMATE AND WERE COMPILED FROM AVAILABLE RM = REMOVE RL = RELOCATE EXISTING UTILITY OR INSTALL NEW INFORMATION PROVIDED BY PUBLIC AND PRIVATE UTILITY PROVIDERS, SOME FIELD SURVEY DATA, AND SITE PERFORMED BY DESIGN-BUILD CONTRACTOR. OBSERVATIONS. THOUGH THIS COMPILATION REPRESENTS THE AVAILABLE INFORMATION OF EXISTING SP = SUPPORT/PROTECT DURING CONSTRUCTION AB = ABANDON IN PLACE UTILITIES, THE INFORMATION PROVIDED HEREON MAY VARY FROM ACTUAL SIZES AND LOCATIONS. WORK TO BE PERFORMED BY OTHERS (MEANS AND METHODS TO BE DETERMINED BY THE DESIGN-BUILD (DESIGN-BUILD CONTRACTOR TO VERIFY IF ABANDONMENT IN 2. THE CONTRACTOR SHALL CONDUCT THEIR OWN RESEARCH AND INVESTIGATIONS WHICH IN THEIR (DESIGN-BUILD CONTRACTOR TO COORDINATE) CONTRACTOR AND UTILITY OWNER) PLACE IS ACCEPTABLE TO UTILITY OR CITY OF REDMOND) PROFESSIONAL OPINION ARE NECESSARY TO EVALUATE THE ACCURACY OF THIS INFORMATION IN ADVANCE OF CONSTRUCTION WORK AND SUBSURFACE PENETRATIONS PERFORMED SO AS TO PREVENT THE IMPACT TO UTILITY SYSTEMS AND THEIR CUSTOMERS. SUCH WORK SHALL BE PERFORMED IN A MANNER XX PRESCRIPTIVE UTILITY WORK TO BE AD = ADJUST TO NEW GRADE NOT FOR PRELIMINARY CONSISTENT WITH THE ORDINARY STANDARD OF CARE. PERFORMED BY DESIGN-BUILD CONTRACTOR **ENGINEERING** CONSTRUCTION SCALE IN FEET RAWING No.: DESIGNED BY **DOWNTOWN REDMOND LINK EXTENSION CONCEPTUAL DESIGN** 5 M. AUSTIN 1" = 20' L90-UCP143 RTS TO DOWNTOWN REDMOND ILENAME: **Parametrix** RLE-L90-UCP131TO164 LOCATION ID: J. BETZVOG REFERENCE **CONFORMED SET** CHECKED BY: CONTRACT No.: **SOUNDTRANSIT** COMPOSITE UTILITIES PLAN CN 0148-18 D. PROCTOR SHEET No.: SR 202/REDMOND WY & NE 76TH ST

REVIEWED BY

09/24/2018

BRAD PHILLIPS


03/29/2019

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APPROVED BY

Y. YANG

CHK APP REVISION

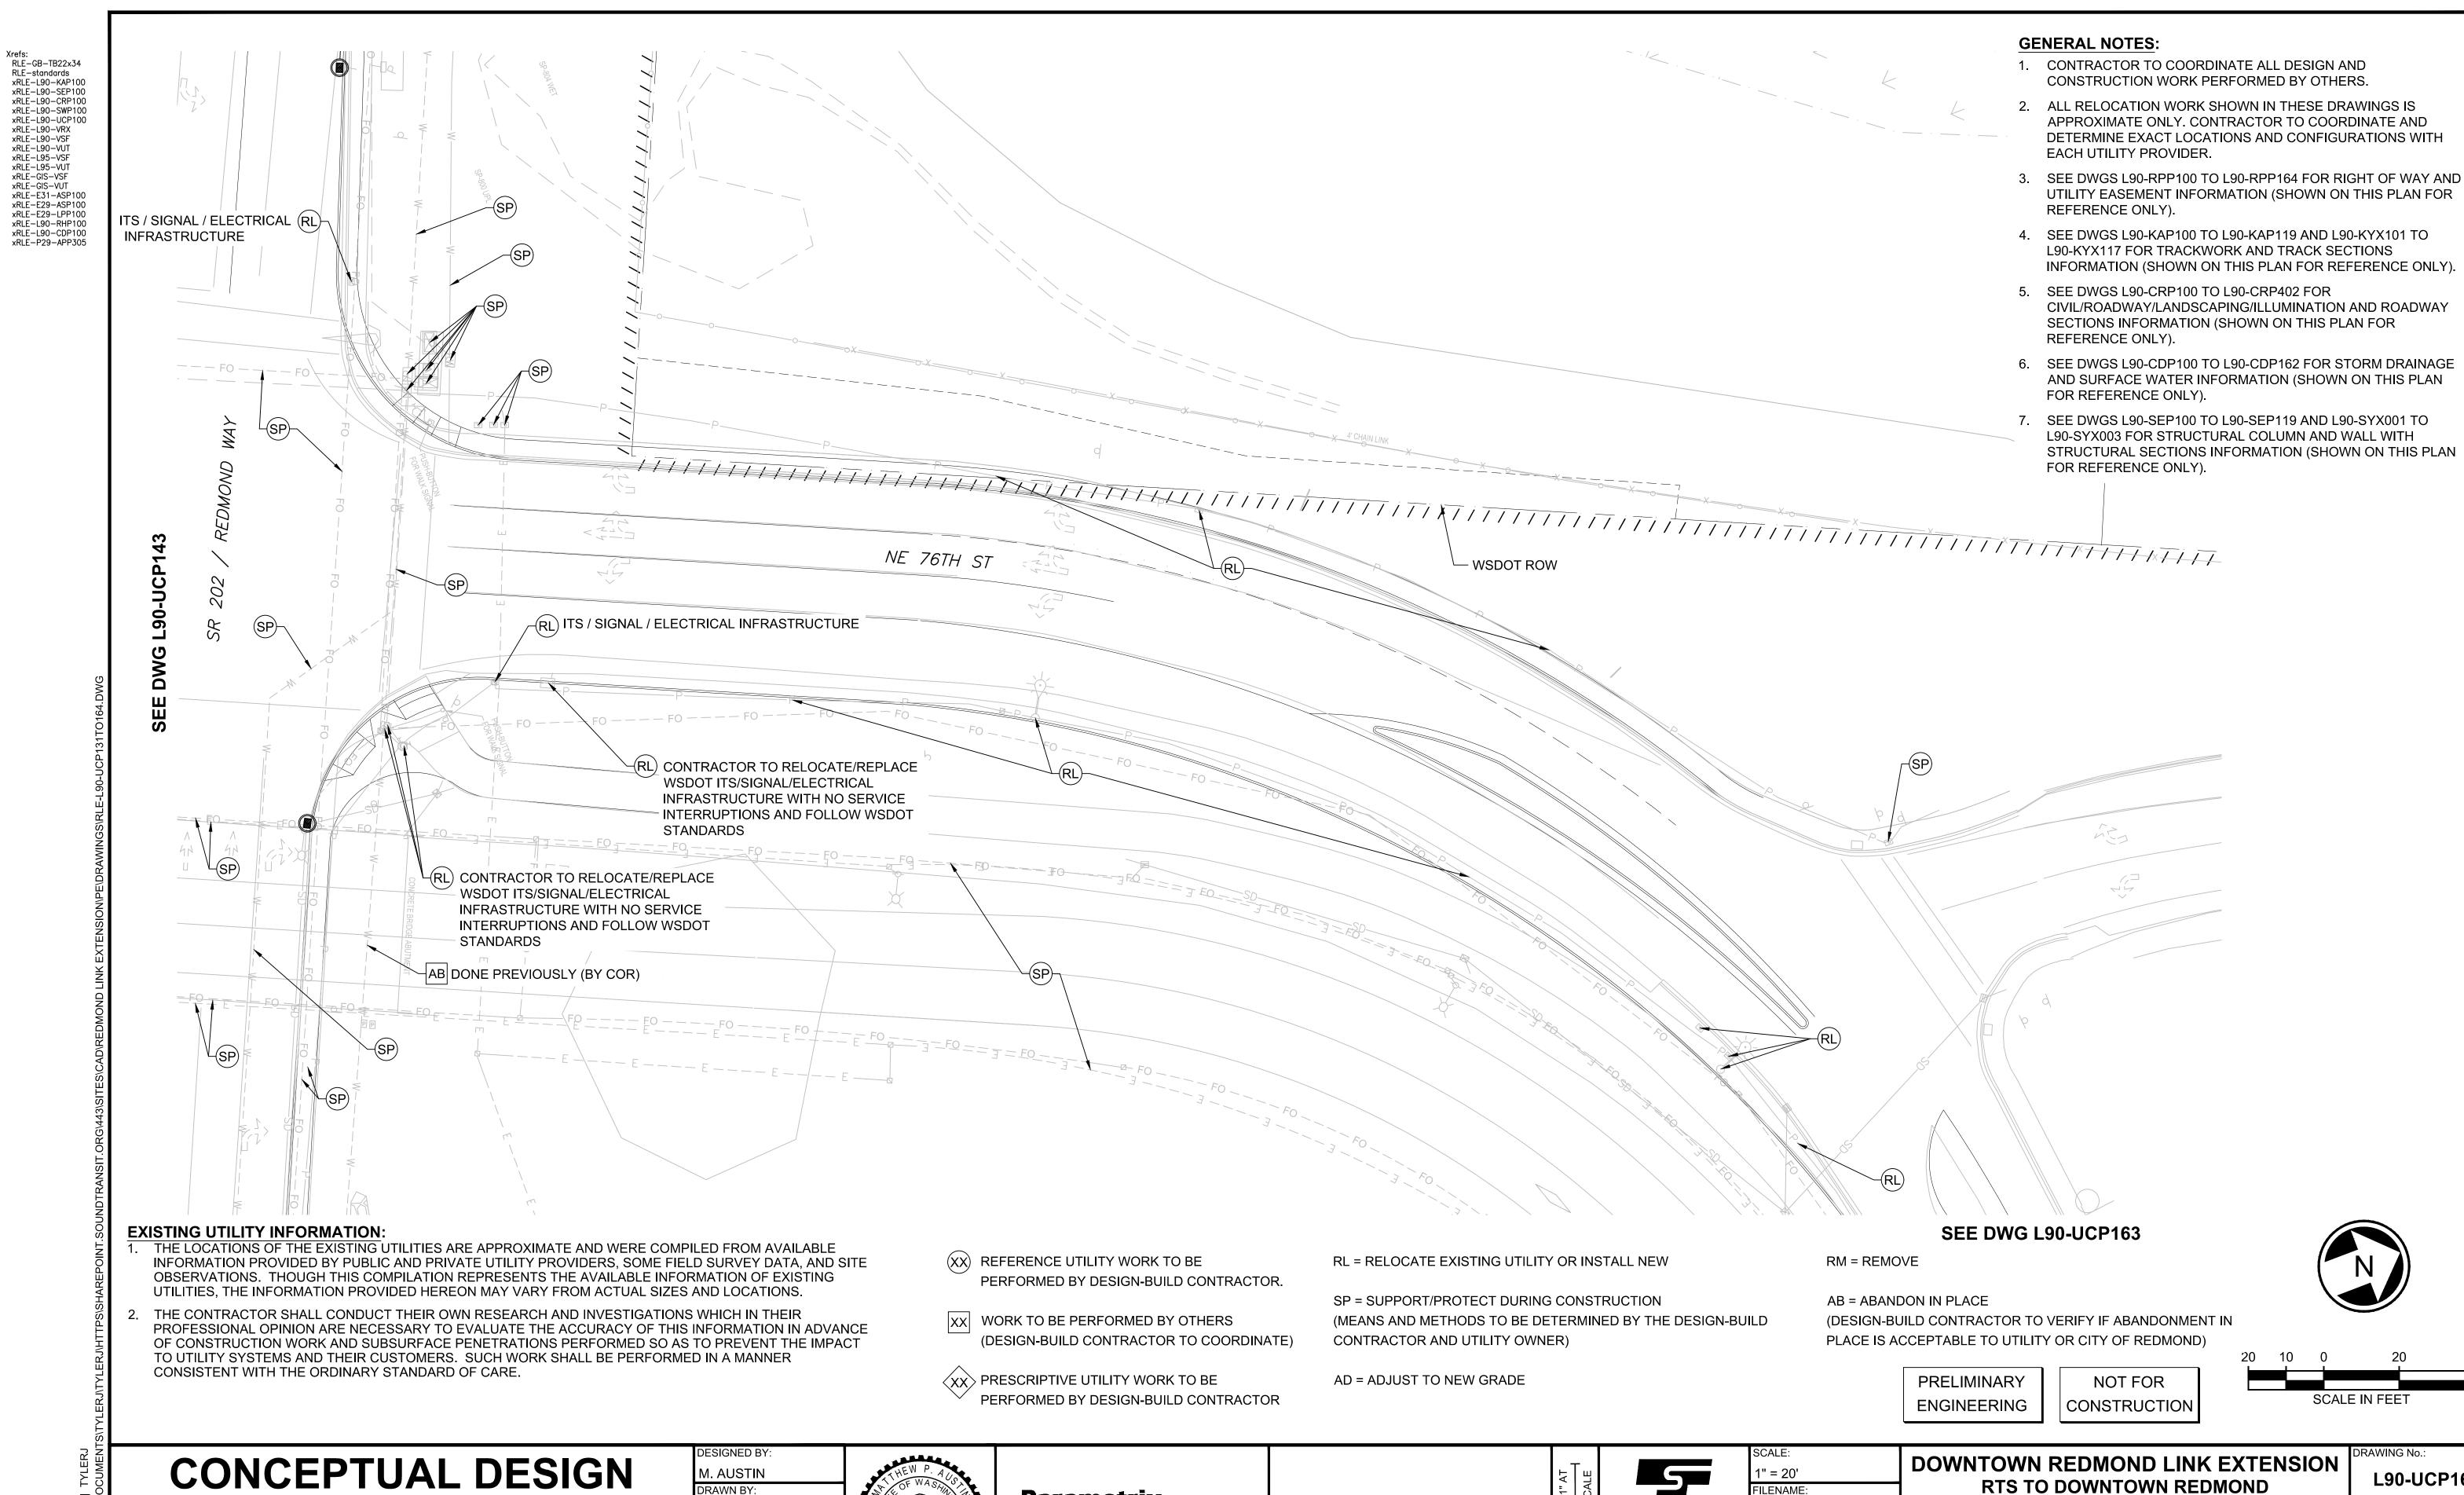

**Parametrix** 

BRAD PHILLIPS

J. BETZVOG

D. PROCTOR

APPROVED BY

Y. YANG

CHECKED BY:

**CONFORMED SET** 

CHK APP REVISION

xRLE-L90-VSF xRLE-L90-VUT

xRLE-L95-VSF xRLE-L95-VUT xRLE-GIS-VSF

xRLE-GIS-VUT

L90-UCP162 LOCATION ID: REFERENCE

COMPOSITE UTILITIES PLAN NE 76TH ST & SR 202/REDMOND WY INTERSECTION

RLE-L90-UCP131TO164

CONTRACT No.:

CN 0148-18

03/29/2019

SoundTransit

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09/24/2018

SCALE IN FEET

RAWING No.:

**GENERAL NOTES:** CONTRACTOR TO COORDINATE ALL DESIGN AND Xrefs: RLE-GB-TB22x34 CONSTRUCTION WORK PERFORMED BY OTHERS. RLE-standards xRLE-L90-KAP100 xRLE-L90-SEP100 2. ALL RELOCATION WORK SHOWN IN THESE DRAWINGS IS xRLE-L90-CRP100 xRLE-L90-SWP100 APPROXIMATE ONLY. CONTRACTOR TO COORDINATE AND xRLE-L90-UCP100 xRLE-L90-VRX DETERMINE EXACT LOCATIONS AND CONFIGURATIONS WITH xRLE-L90-VSF xRLE-L90-VUT EACH UTILITY PROVIDER. xRLE-L95-VSF xRLE-L95-VUT 3. SEE DWGS L90-RPP100 TO L90-RPP160 FOR RIGHT OF WAY AND xRLE-GIS-VSF xRLE-GIS-VUT UTILITY EASEMENT INFORMATION (SHOWN ON THIS PLAN FOR xRLE-E31-ASP100 REFERENCE ONLY). xRLE-E29-ASP100 xRLE-E29-LPP100 4. SEE DWGS L90-KAP100 TO L90-KAP119 AND L90-KYX101 TO xRLE-L90-RHP100 xRLE-L90-CDP100 xRLE-P29-APP305 L90-KYX119 FOR TRACKWORK AND TRACK SECTIONS INFORMATION (SHOWN ON THIS PLAN FOR REFERENCE ONLY). SEE DWGS L90-CRP100 TO L90-CRP302 FOR CIVIL/ROADWAY/LANDSCAPING/ILLUMINATION AND ROADWAY SECTIONS INFORMATION (SHOWN ON THIS PLAN FOR REFERENCE ONLY). 6. SEE DWGS L90-CDP100 TO L90-CDP162 FOR STORM DRAINAGE AND SURFACE WATER INFORMATION (SHOWN ON THIS PLAN FOR REFERENCE ONLY). SEE DWGS L90-SEP100 TO L90-SEP119 FOR STRUCTURAL COLUMN AND STRUCTURAL WALL INFORMATION (SHOWN ON THIS PLAN FOR REFERENCE ONLY). VIIIIIIIIIIII NE 76TH ST **EXISTING UTILITY INFORMATION:** 1. THE LOCATIONS OF THE EXISTING UTILITIES ARE APPROXIMATE AND WERE COMPILED FROM AVAILABLE (XX) REFERENCE UTILITY WORK TO BE RM = REMOVE INFORMATION PROVIDED BY PUBLIC AND PRIVATE UTILITY PROVIDERS, SOME FIELD SURVEY DATA, AND SITE RL = RELOCATE EXISTING UTILITY OR INSTALL NEW OBSERVATIONS. THOUGH THIS COMPILATION REPRESENTS THE AVAILABLE INFORMATION OF EXISTING PERFORMED BY DESIGN-BUILD CONTRACTOR. UTILITIES. THE INFORMATION PROVIDED HEREON MAY VARY FROM ACTUAL SIZES AND LOCATIONS. SP = SUPPORT/PROTECT DURING CONSTRUCTION AB = ABANDON IN PLACE 2. THE CONTRACTOR SHALL CONDUCT THEIR OWN RESEARCH AND INVESTIGATIONS WHICH IN THEIR XX WORK TO BE PERFORMED BY OTHERS (MEANS AND METHODS TO BE DETERMINED BY THE DESIGN-BUILD (DESIGN-BUILD CONTRACTOR TO VERIFY IF ABANDONMENT IN PROFESSIONAL OPINION ARE NECESSARY TO EVALUATE THE ACCURACY OF THIS INFORMATION IN ADVANCE (DESIGN-BUILD CONTRACTOR TO COORDINATE) PLACE IS ACCEPTABLE TO UTILITY OR CITY OF REDMOND) CONTRACTOR AND UTILITY OWNER) OF CONSTRUCTION WORK AND SUBSURFACE PENETRATIONS PERFORMED SO AS TO PREVENT THE IMPACT TO UTILITY SYSTEMS AND THEIR CUSTOMERS. SUCH WORK SHALL BE PERFORMED IN A MANNER CONSISTENT WITH THE ORDINARY STANDARD OF CARE. XX PRESCRIPTIVE UTILITY WORK TO BE PRELIMINARY AD = ADJUST TO NEW GRADE **NOT FOR** PERFORMED BY DESIGN-BUILD CONTRACTOR SCALE IN FEET **ENGINEERING** CONSTRUCTION RAWING No.: **DOWNTOWN REDMOND LINK EXTENSION CONCEPTUAL DESIGN** M. AUSTIN 1" = 20' L90-UCP163 RTS TO DOWNTOWN REDMOND ILENAME: **Parametrix** RLE-L90-UCP131TO164 LOCATION ID: J. BETZVOG REFERENCE **CONFORMED SET** CONTRACT No.: CHECKED BY: SoundTransit COMPOSITE UTILITIES PLAN D. PROCTOR CN 0148-18

CHK APP REVISION

APPROVED BY

BRAD PHILLIPS

09/24/2018

REVIEWED BY:

03/29/2019

NE 76TH ST

306

**GENERAL NOTES:** Xrefs: RLE-GB-TB22x34 1. CONTRACTOR TO COORDINATE ALL DESIGN AND RLE-Standards
RLE-L90-KAP100

RRLE-L90-SEP100

xRLE-L90-CRP100

xRLE-L90-SWP100 CONSTRUCTION WORK PERFORMED BY OTHERS. 2. ALL RELOCATION WORK SHOWN IN THESE DRAWINGS IS APPROXIMATE ONLY. CONTRACTOR TO COORDINATE AND xRLE-L90-UCP100 xRLE-L90-VRX DETERMINE EXACT LOCATIONS AND CONFIGURATIONS WITH xRLE-L90-VSF xRLE-L90-VUT EACH UTILITY PROVIDER. xRLE-L90-V01 xRLE-L95-VSF xRLE-L95-VUT xRLE-GIS-VSF xRLE-GIS-VUT xRLE-E31-ASP100 3. SEE DWGS L90-RPP100 TO L90-RPP164 FOR RIGHT OF WAY AND UTILITY EASEMENT INFORMATION (SHOWN ON THIS PLAN FOR REFERENCE ONLY). xRLE-E29-ASP100 xRLE-E29-LPP100 xRLE-L90-RHP100 4. SEE DWGS L90-KAP100 TO L90-KAP119 AND L90-KYX101 TO xRLE-L90-CDP100 xRLE-P29-APP305 L90-KYX117 FOR TRACKWORK AND TRACK SECTIONS INFORMATION (SHOWN ON THIS PLAN FOR REFERENCE ONLY). SEE DWGS L90-CRP100 TO L90-CRP402 FOR CIVIL/ROADWAY/LANDSCAPING/ILLUMINATION AND ROADWAY SECTIONS INFORMATION (SHOWN ON THIS PLAN FOR REFERENCE ONLY). SEE DWGS L90-CDP100 TO L90-CDP162 FOR STORM DRAINAGE AND SURFACE WATER INFORMATION (SHOWN ON THIS PLAN FOR REFERENCE ONLY). 7. SEE DWGS L90-SEP100 TO L90-SEP119 AND L90-SYX001 TO L90-SYX003 FOR STRUCTURAL COLUMN AND WALL WITH STRUCTURAL SECTIONS INFORMATION (SHOWN ON THIS PLAN FOR REFERENCE ONLY). **EXISTING UTILITY INFORMATION:** 1. THE LOCATIONS OF THE EXISTING UTILITIES ARE APPROXIMATE AND WERE COMPILED FROM AVAILABLE (XX) REFERENCE UTILITY WORK TO BE RM = REMOVE RL = RELOCATE EXISTING UTILITY OR INSTALL NEW INFORMATION PROVIDED BY PUBLIC AND PRIVATE UTILITY PROVIDERS, SOME FIELD SURVEY DATA, AND SITE OBSERVATIONS. THOUGH THIS COMPILATION REPRESENTS THE AVAILABLE INFORMATION OF EXISTING PERFORMED BY DESIGN-BUILD CONTRACTOR. UTILITIES, THE INFORMATION PROVIDED HEREON MAY VARY FROM ACTUAL SIZES AND LOCATIONS. SP = SUPPORT/PROTECT DURING CONSTRUCTION AB = ABANDON IN PLACE 2. THE CONTRACTOR SHALL CONDUCT THEIR OWN RESEARCH AND INVESTIGATIONS WHICH IN THEIR XX WORK TO BE PERFORMED BY OTHERS (MEANS AND METHODS TO BE DETERMINED BY THE DESIGN-BUILD (DESIGN-BUILD CONTRACTOR TO VERIFY IF ABANDONMENT IN PROFESSIONAL OPINION ARE NECESSARY TO EVALUATE THE ACCURACY OF THIS INFORMATION IN ADVANCE (DESIGN-BUILD CONTRACTOR TO COORDINATE) CONTRACTOR AND UTILITY OWNER) PLACE IS ACCEPTABLE TO UTILITY OR CITY OF REDMOND) OF CONSTRUCTION WORK AND SUBSURFACE PENETRATIONS PERFORMED SO AS TO PREVENT THE IMPACT TO UTILITY SYSTEMS AND THEIR CUSTOMERS. SUCH WORK SHALL BE PERFORMED IN A MANNER CONSISTENT WITH THE ORDINARY STANDARD OF CARE. XX PRESCRIPTIVE UTILITY WORK TO BE PRELIMINARY AD = ADJUST TO NEW GRADE NOT FOR PERFORMED BY DESIGN-BUILD CONTRACTOR SCALE IN FEET **ENGINEERING** CONSTRUCTION **DOWNTOWN REDMOND LINK EXTENSION CONCEPTUAL DESIGN** M. AUSTIN 1" = 20' L90-UCP164 RTS TO DOWNTOWN REDMOND **Parametrix** LOCATION ID: J. BETZVOG RLE-L90-UCP131TO164 REFERENCE **CONFORMED SET** CHECKED BY: CONTRACT No.: SoundTransit

REVIEWED BY:

09/24/2018

BRAD PHILLIPS

CHK APP REVISION


D. PROCTOR


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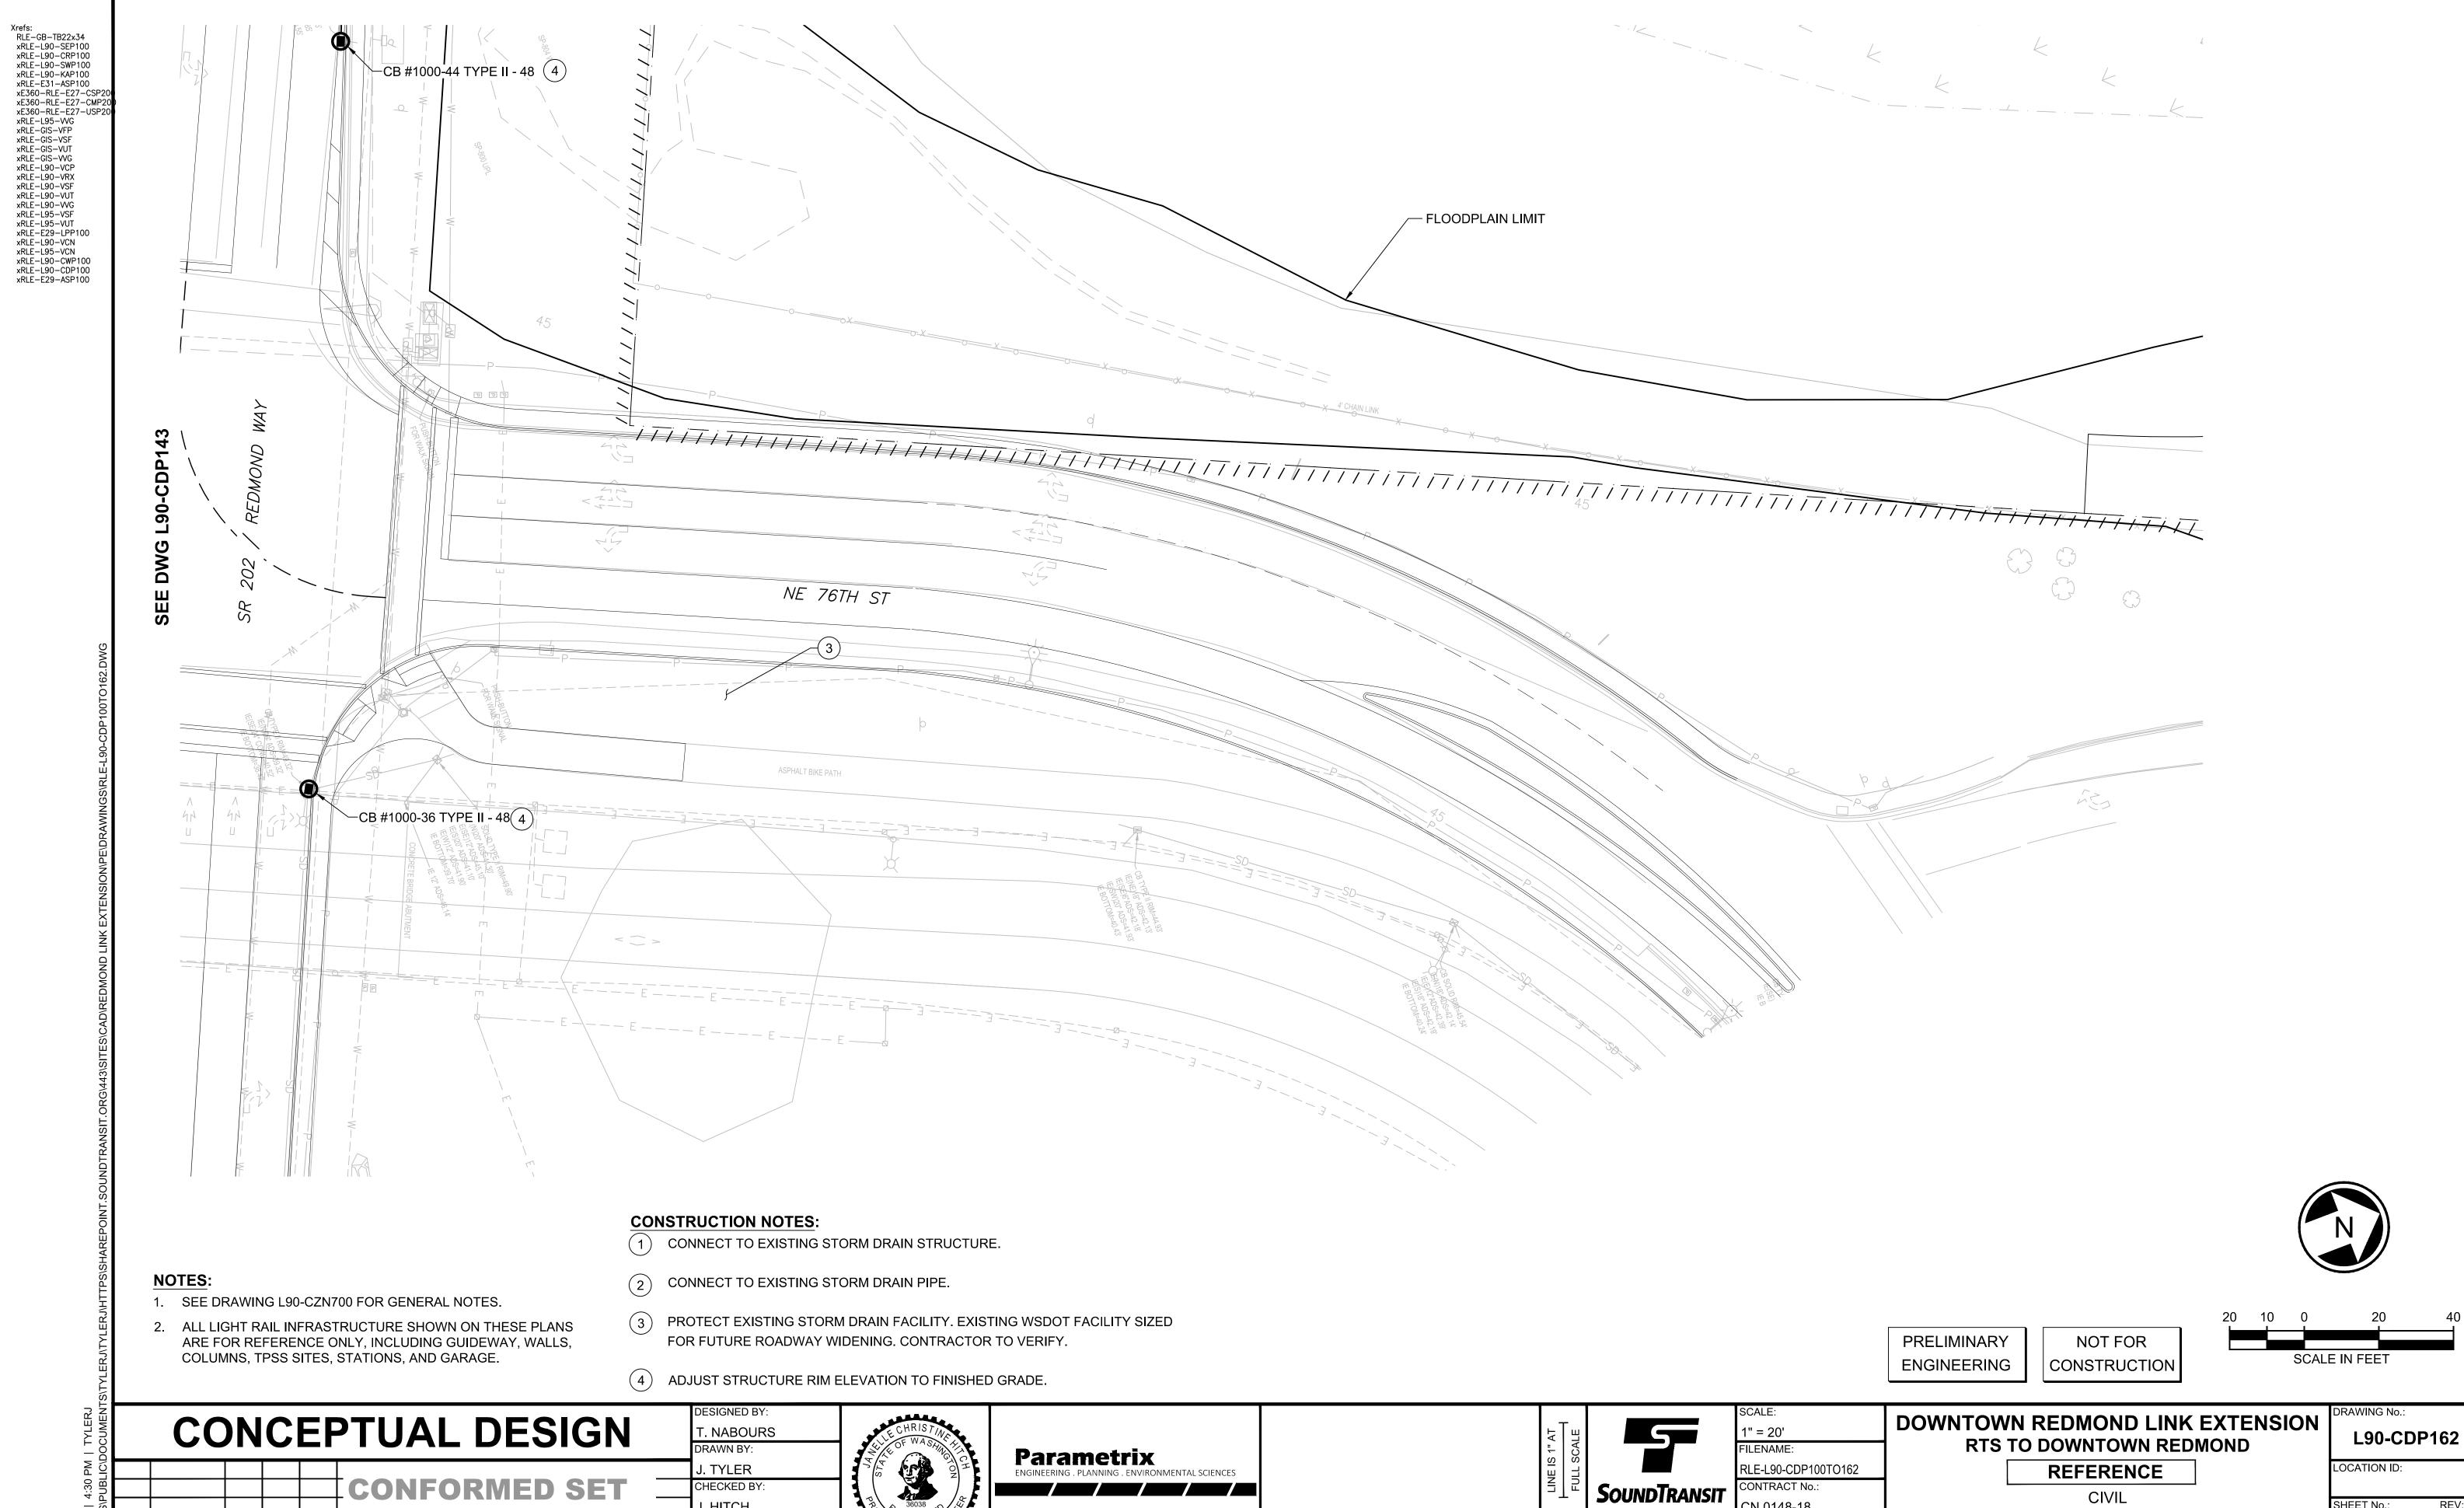
COMPOSITE UTILITIES PLAN NE 76TH ST - NORTH

CN 0148-18

03/29/2019



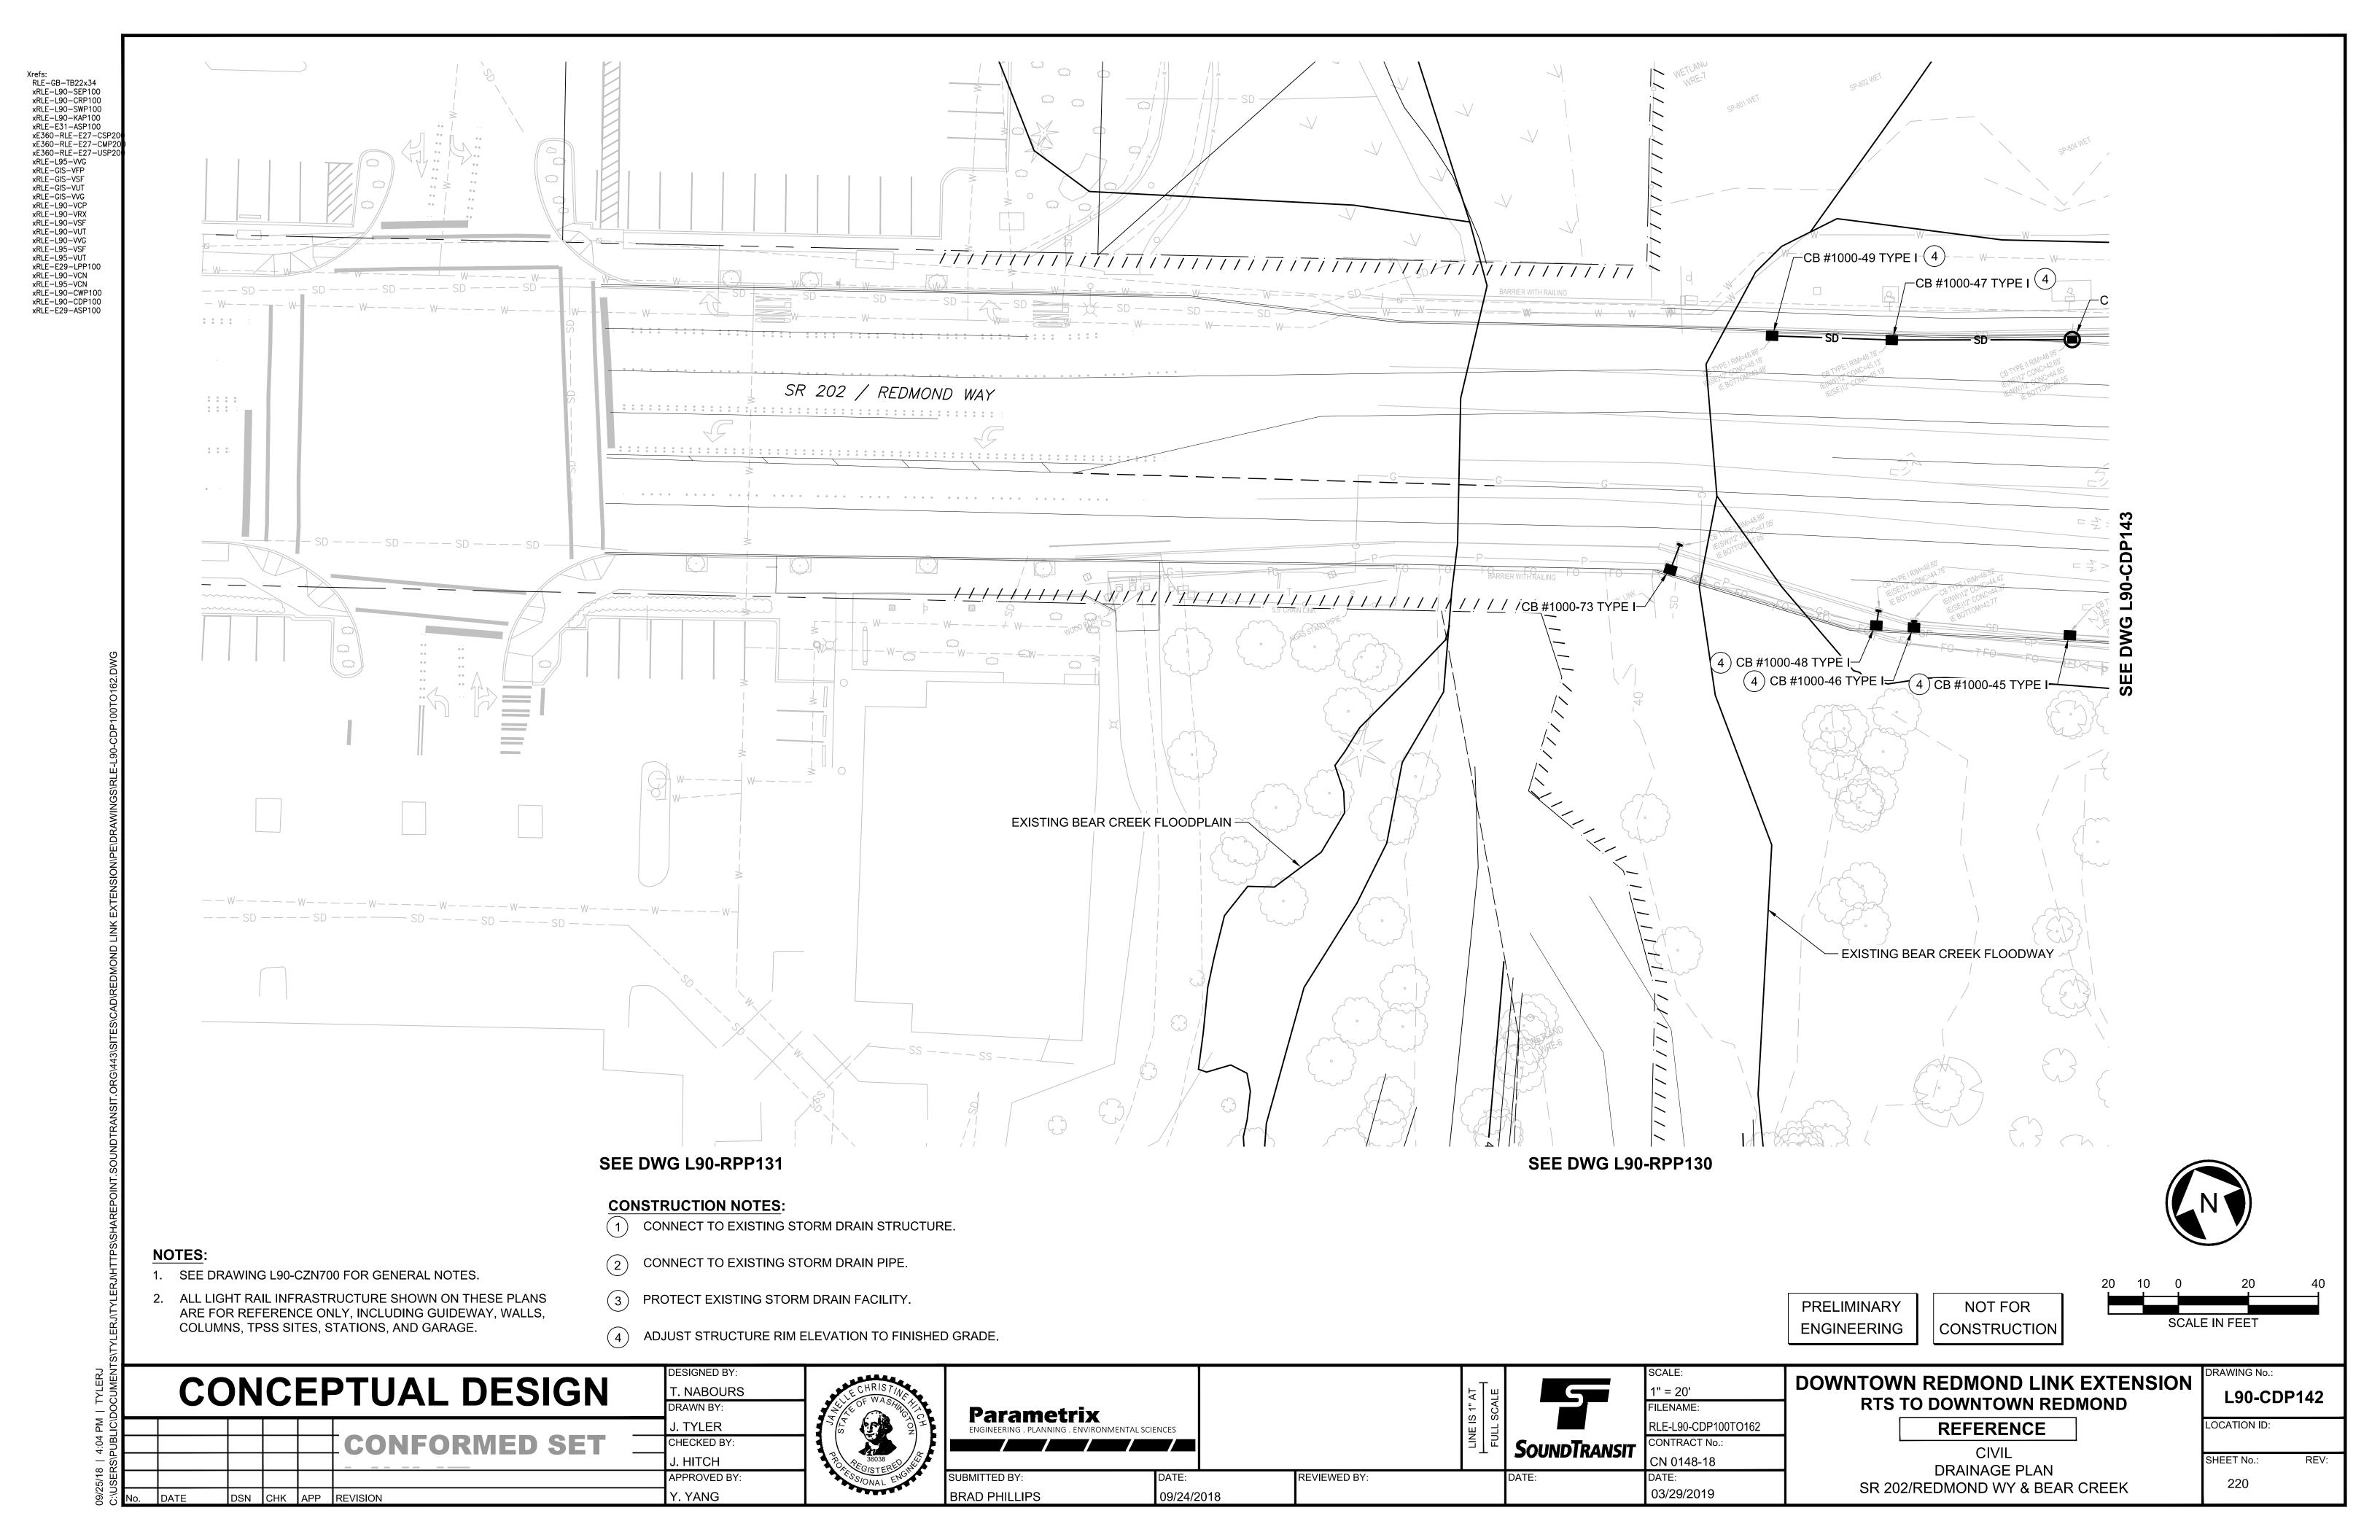

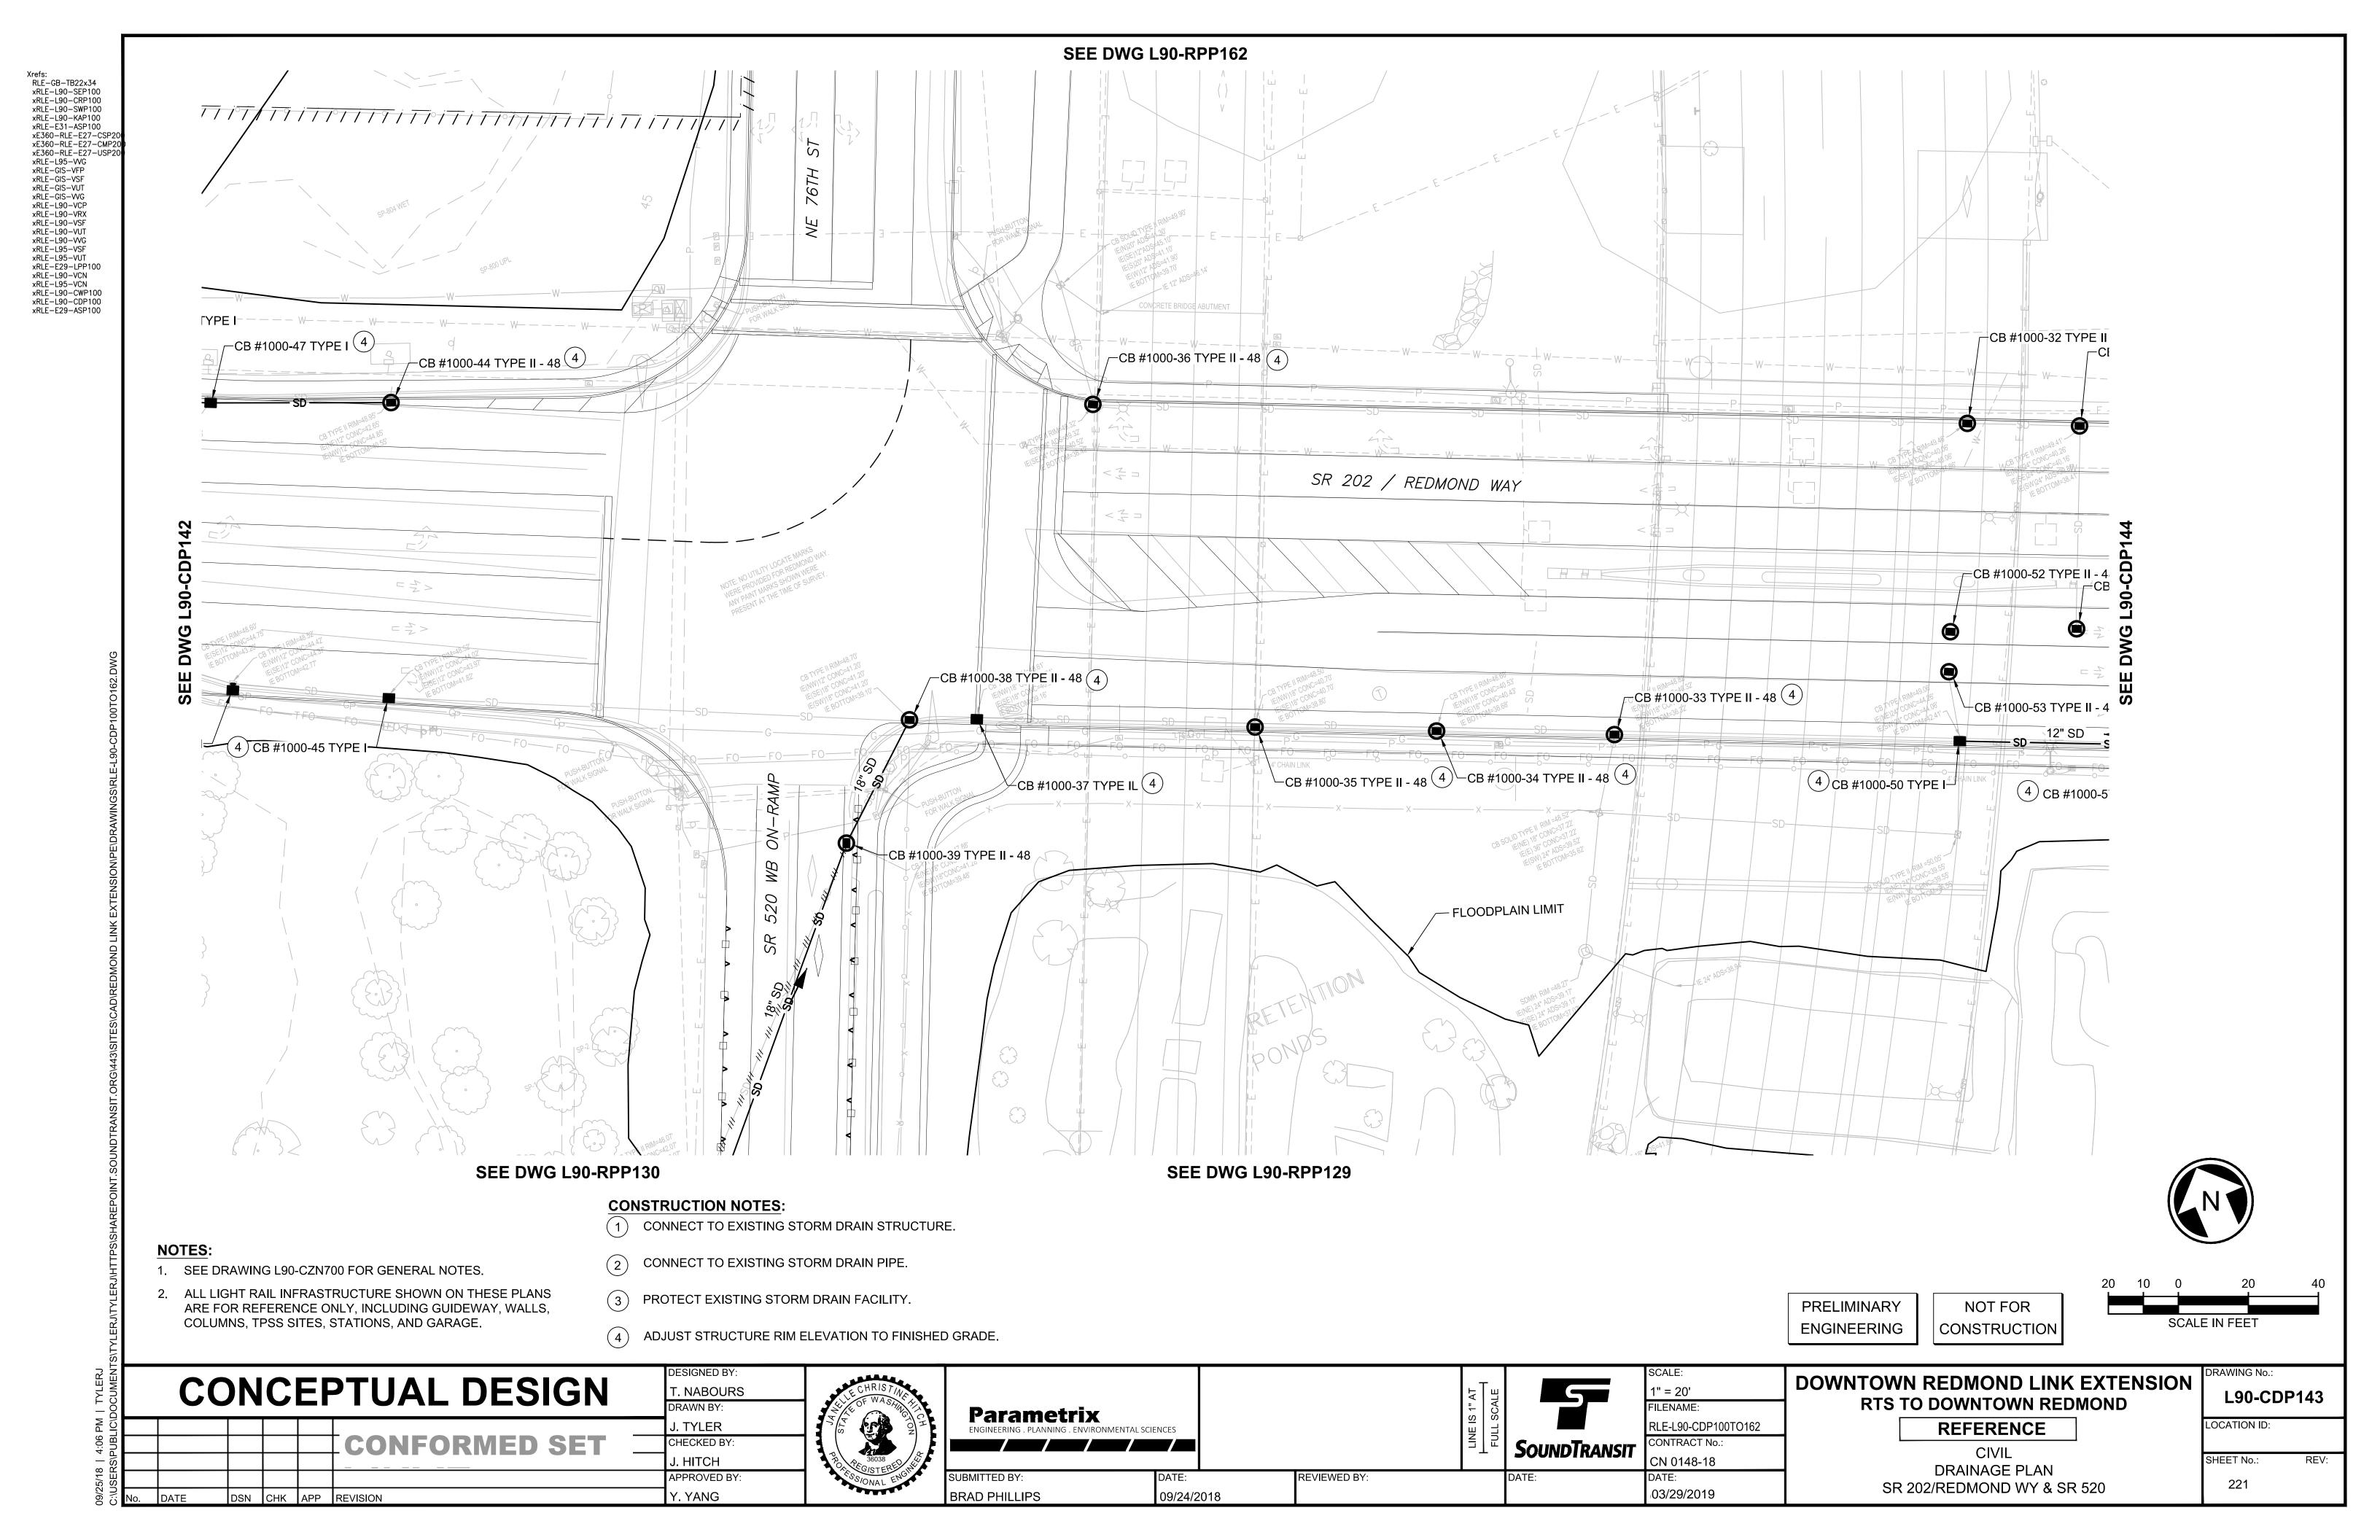

REVIEWED BY:

09/24/2018

BRAD PHILLIPS

APPROVED BY

CIVIL

DRAINAGE PLAN

NE 76TH ST & SR 202/REDMOND WY INTERSECTION

CN 0148-18

03/29/2019

DSN CHK APP REVISION